

# BID SOLICITATION AND CONSTRUCTION DOCUMENTS

**FOR** 

2007 CLEANING & DEMOLITION PROJECT AND CAMU – PHASE 2 CELL PROJECT

ASARCO EAST HELENA PLANT EAST HELENA, MONTANA

SECTION VIII DRAWINGS

Contact(s):

Address:

P.O. Box 1230 East Helena, MT 59635

January 2007



### ASARCO LLC EAST HELENA PLANT

# 2007 CLEANING & DEMOLITION PROJECT AND CAMU PHASE 2 CELL PROJECT

**JANUARY 2007** 

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DWG. NO.	
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17 18 19 20 21 22 23	TEMPORARY CAP PHASE IV - STAGE 2 - PART 1  TEMPORARY CAP PHASE IV - STAGE 2 - PART 2  TEMPORARY CAP PHASE IV - STAGE 2 - PART 3  TEMPORARY CAP PHASE IV - STAGE 2 & ADDITIVE ALTERNATIVE "A"  TEMPORARY CAP PHASE IV - ADDITIVE ALTERNATIVE "A" & "B"  DETAILS
17 18 19 20 21 22 23	TEMPORARY CAP PHASE IV - STAGE 2 - PART 1  TEMPORARY CAP PHASE IV - STAGE 2 - PART 2  TEMPORARY CAP PHASE IV - STAGE 2 - PART 3  TEMPORARY CAP PHASE IV - STAGE 2 & ADDITIVE ALTERNATIVE "A"  TEMPORARY CAP PHASE IV - ADDITIVE ALTERNATIVE "A" & "B"  DETAILS  DETAILS
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17 18 19 20 21 22 23 CAMU P	TEMPORARY CAP PHASE IV - STAGE 2 - PART 1  TEMPORARY CAP PHASE IV - STAGE 2 - PART 2  TEMPORARY CAP PHASE IV - STAGE 2 - PART 3  TEMPORARY CAP PHASE IV - STAGE 2 & ADDITIVE ALTERNATIVE "A"  TEMPORARY CAP PHASE IV - ADDITIVE ALTERNATIVE "A" & "B"  DETAILS  DETAILS  HASE 2 PLAN SHEETS  WASTE STOCKPILES AND HAUL ROUTES  EXCAVATION SITE PLAN
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17 18 19 20 21 22 23 CAMU P 24 25 26 27 28 29 30	TEMPORARY CAP PHASE IV - STAGE 2 - PART 1  TEMPORARY CAP PHASE IV - STAGE 2 - PART 2  TEMPORARY CAP PHASE IV - STAGE 2 - PART 3  TEMPORARY CAP PHASE IV - STAGE 2 & ADDITIVE ALTERNATIVE "A"  TEMPORARY CAP PHASE IV - ADDITIVE ALTERNATIVE "A" & "B"  DETAILS  DETAILS  HASE 2 PLAN SHEETS  WASTE STOCKPILES AND HAUL ROUTES  EXCAVATION SITE PLAN  EROSION CONTROL PLAN - WASTE PLACEMENT PHASE  EROSION CONTROL PLAN - WASTE PLACEMENT PHASE  CROSS SECTIONS  LEACHATE DETECTION, COLLECTION, AND REMOVAL SYSTEM SECTIONS AND DETAILS  CAP AND BOTTOM LINER DETAILS

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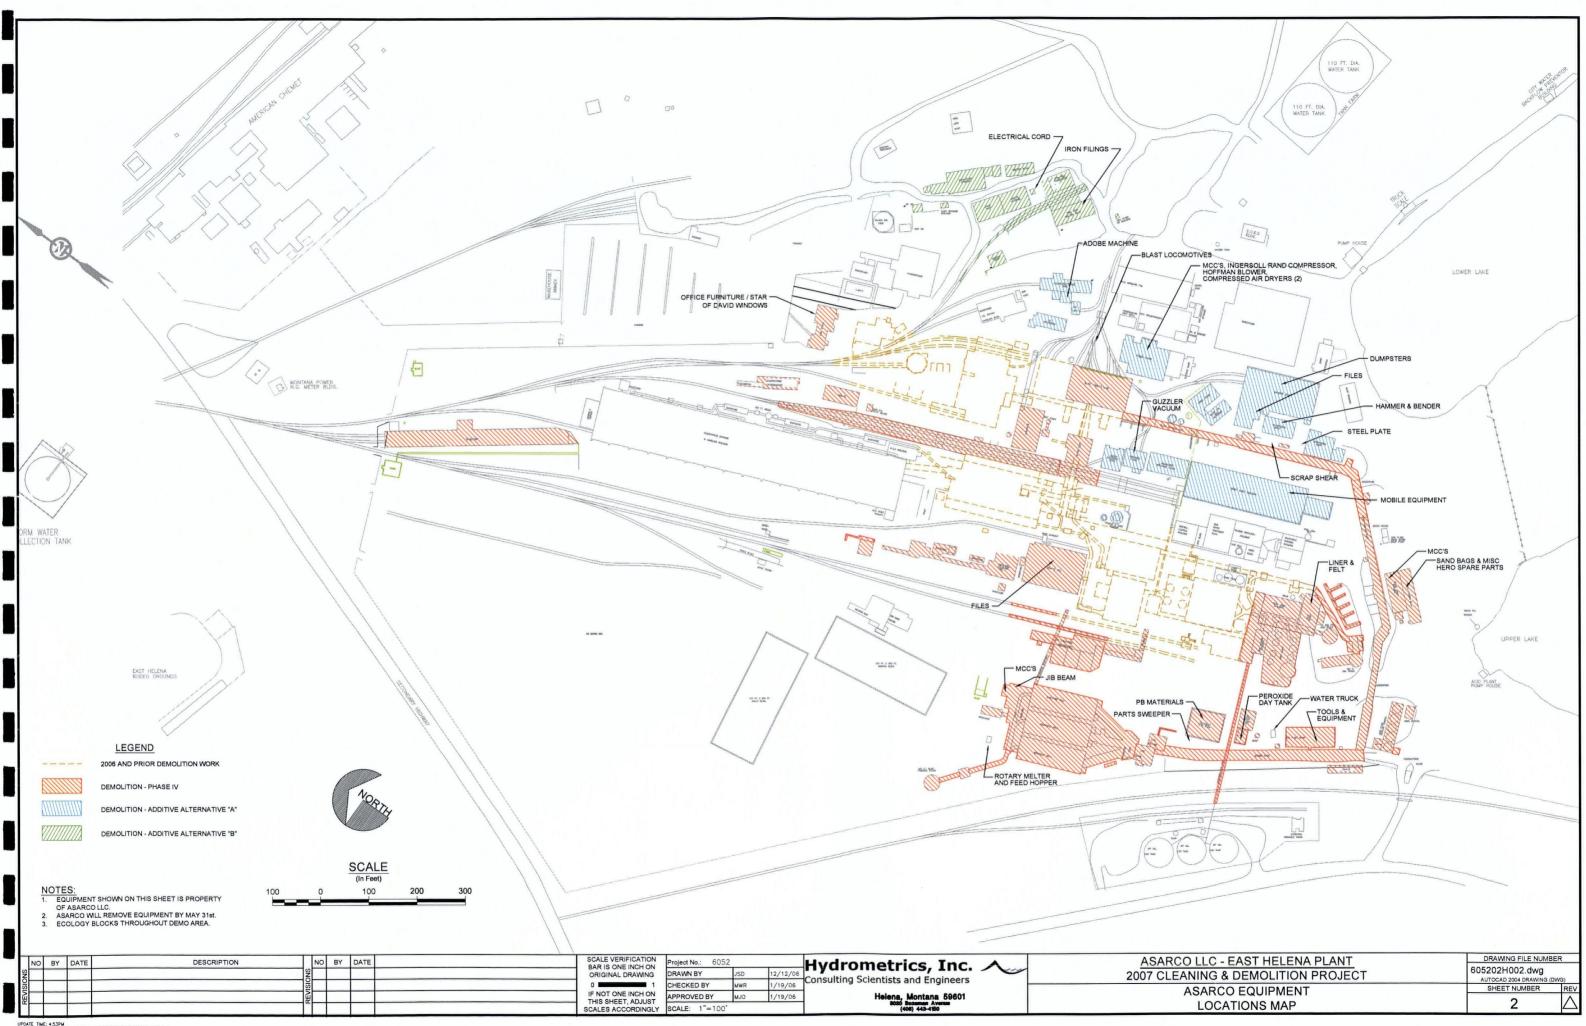
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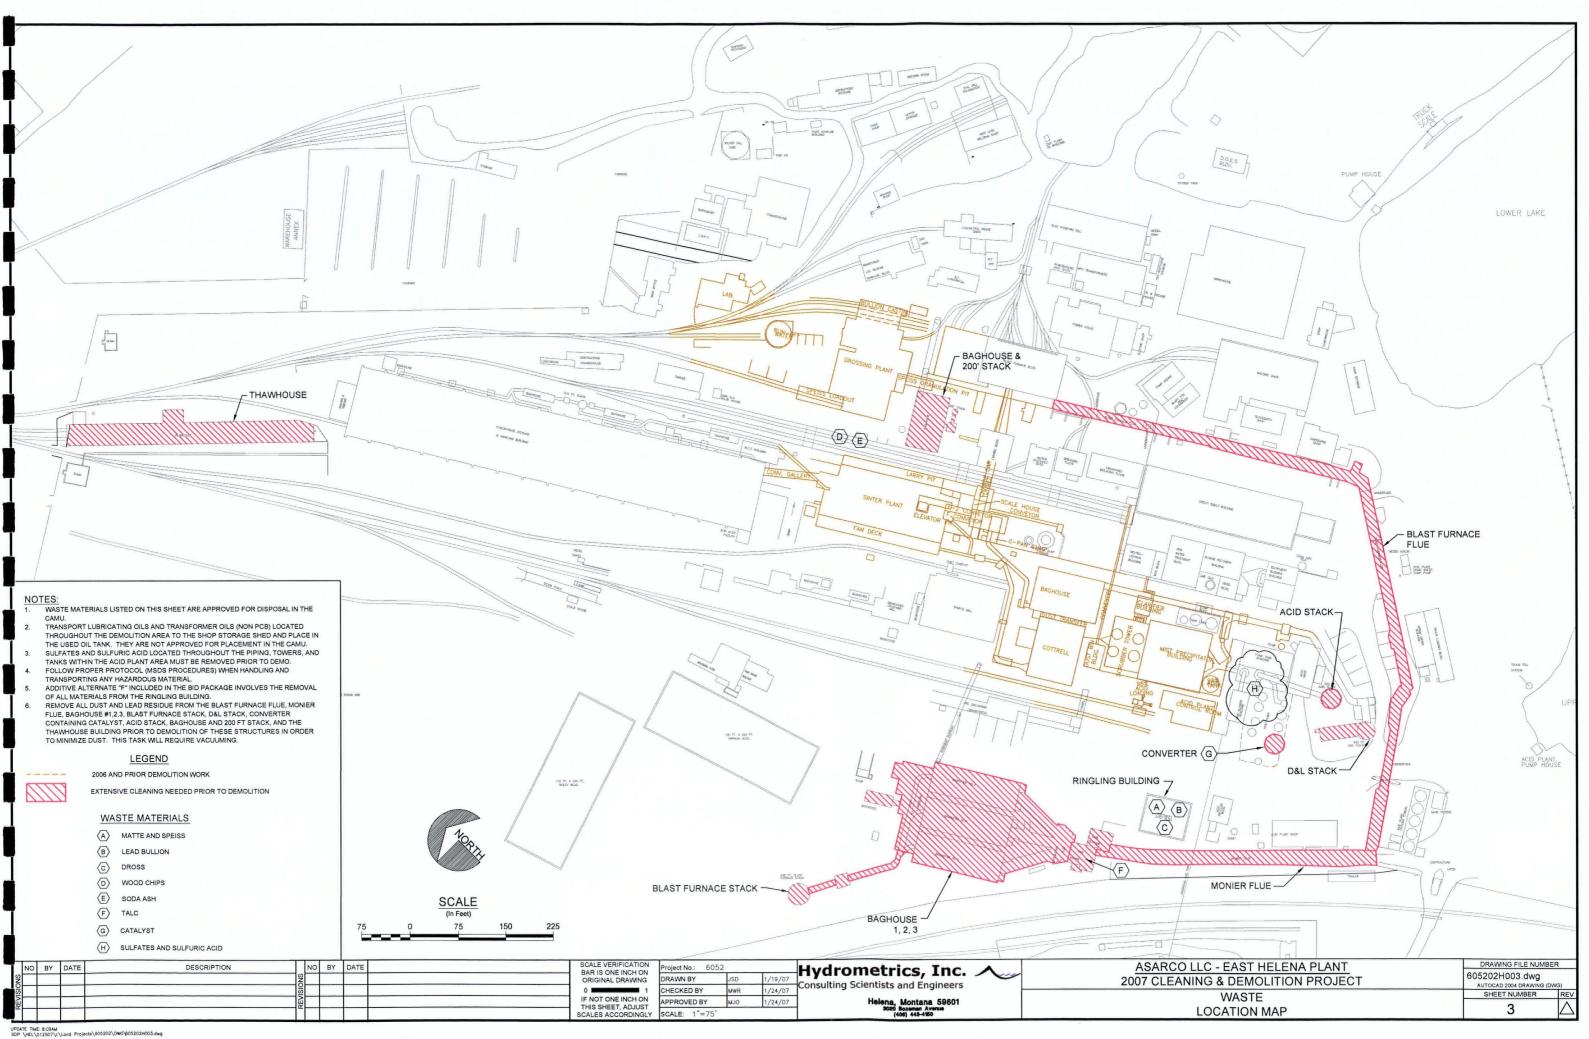
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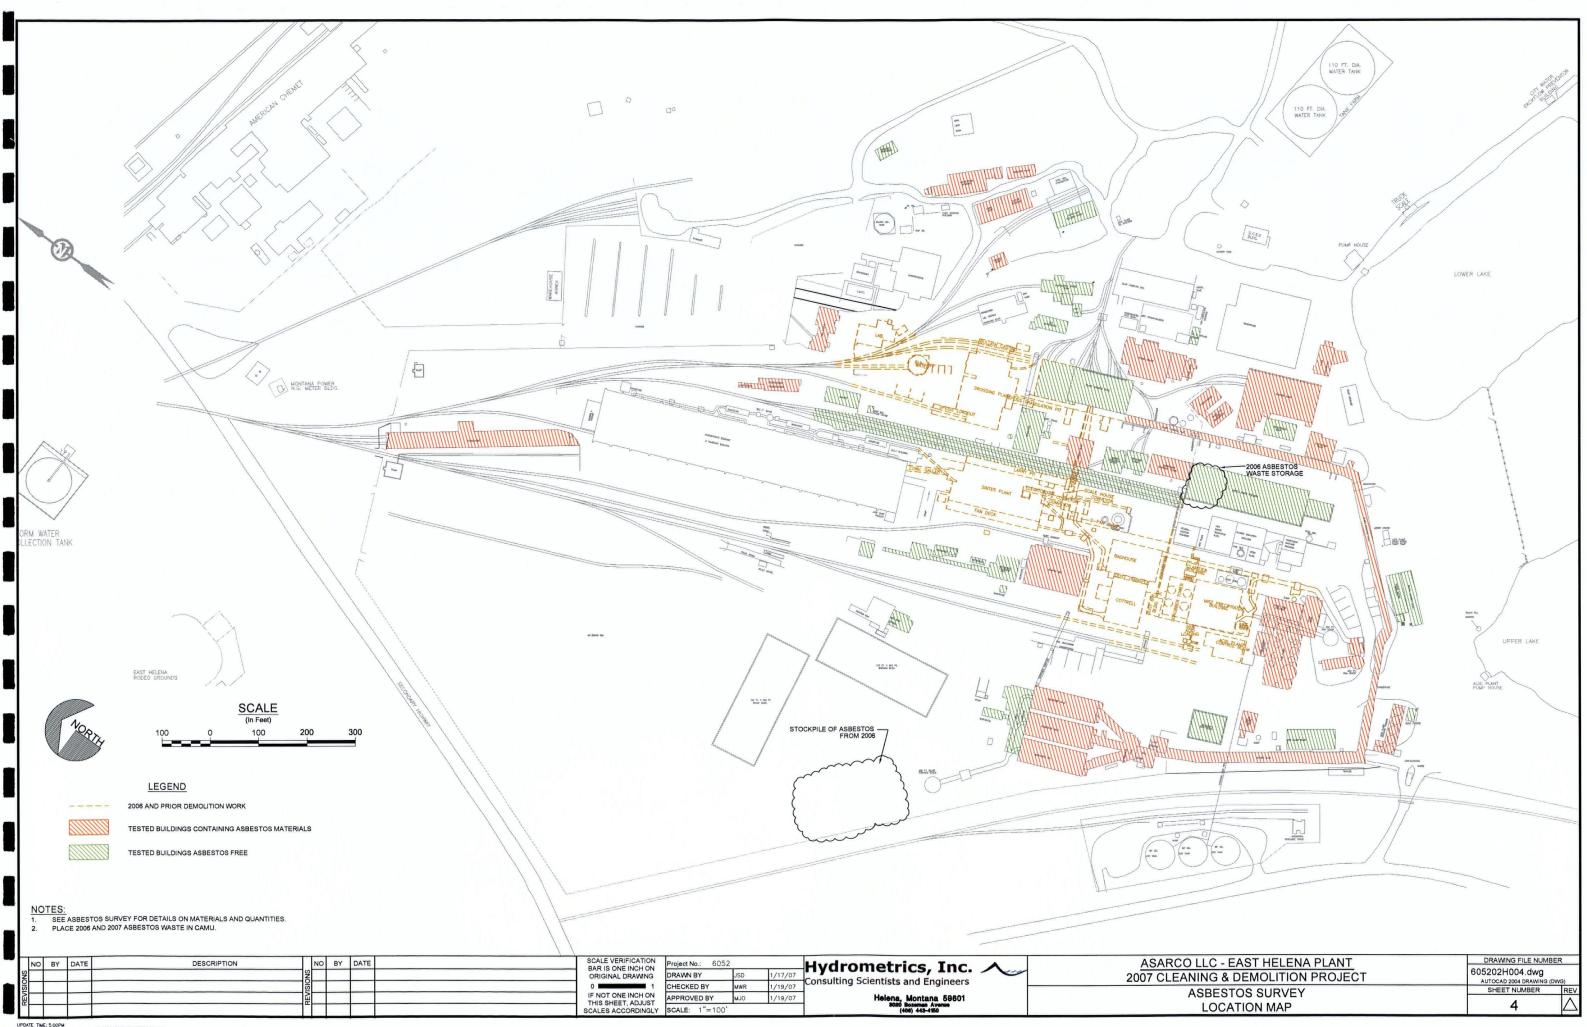
ASARCO LLC - EAST HELENA PLANT
2007 CLEANING & DEMOLITION PROJECT AND CAMU PHASE 2 CELL PROJECT
DRAWING INDEX &


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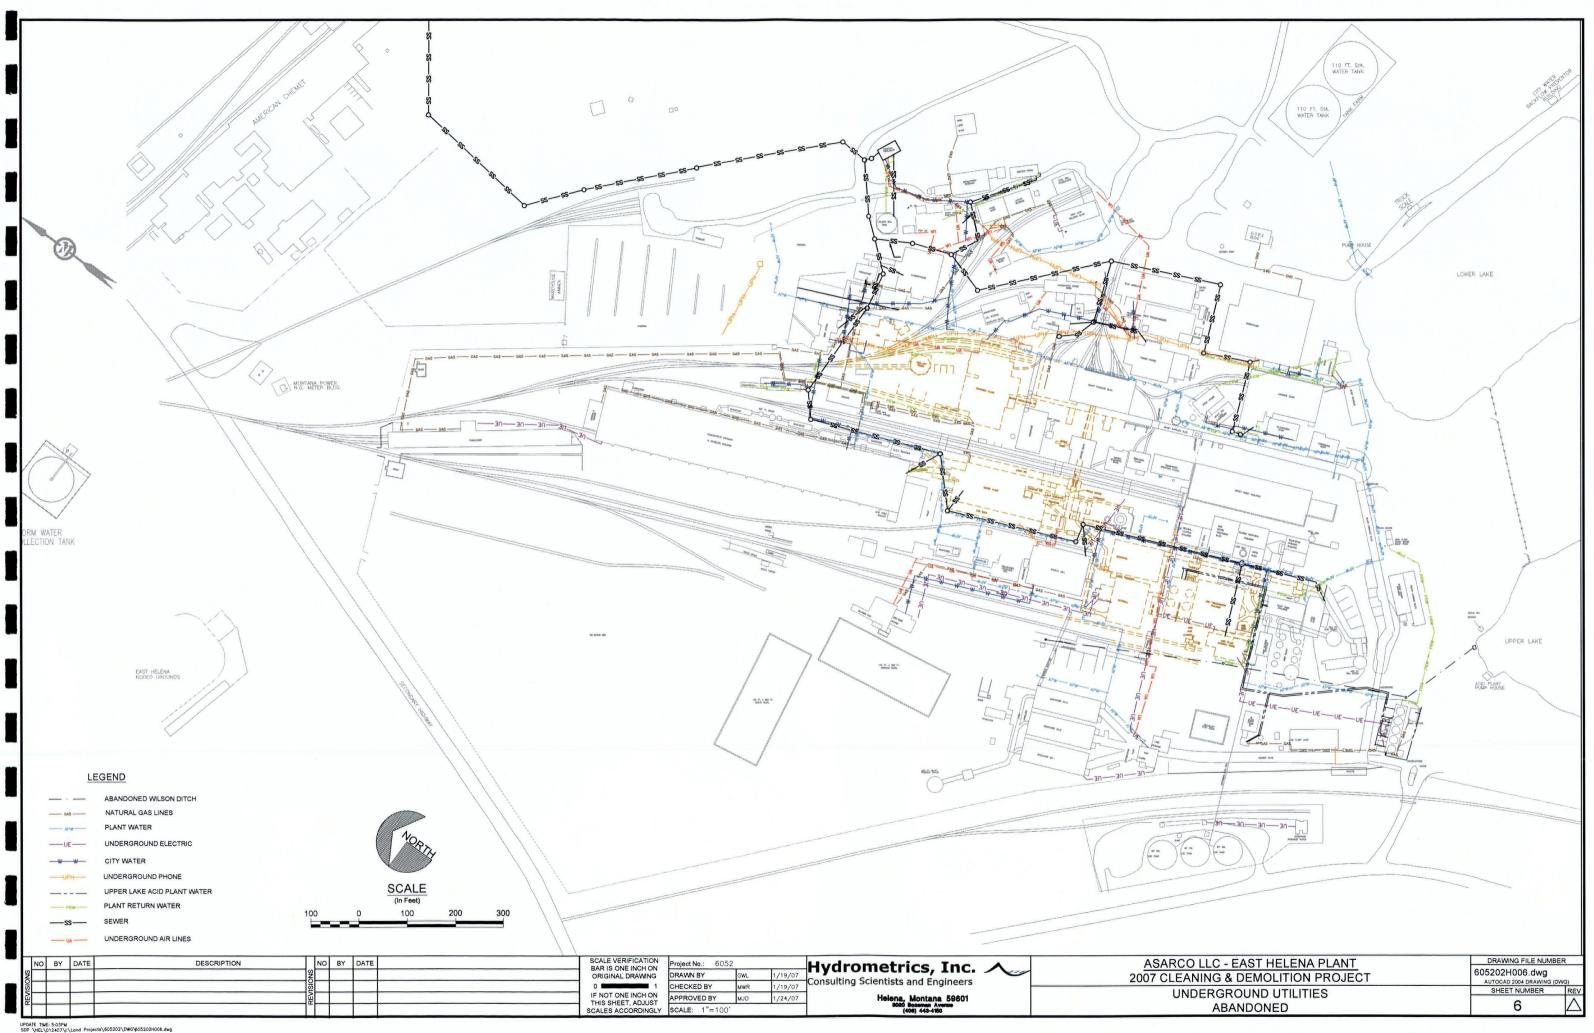
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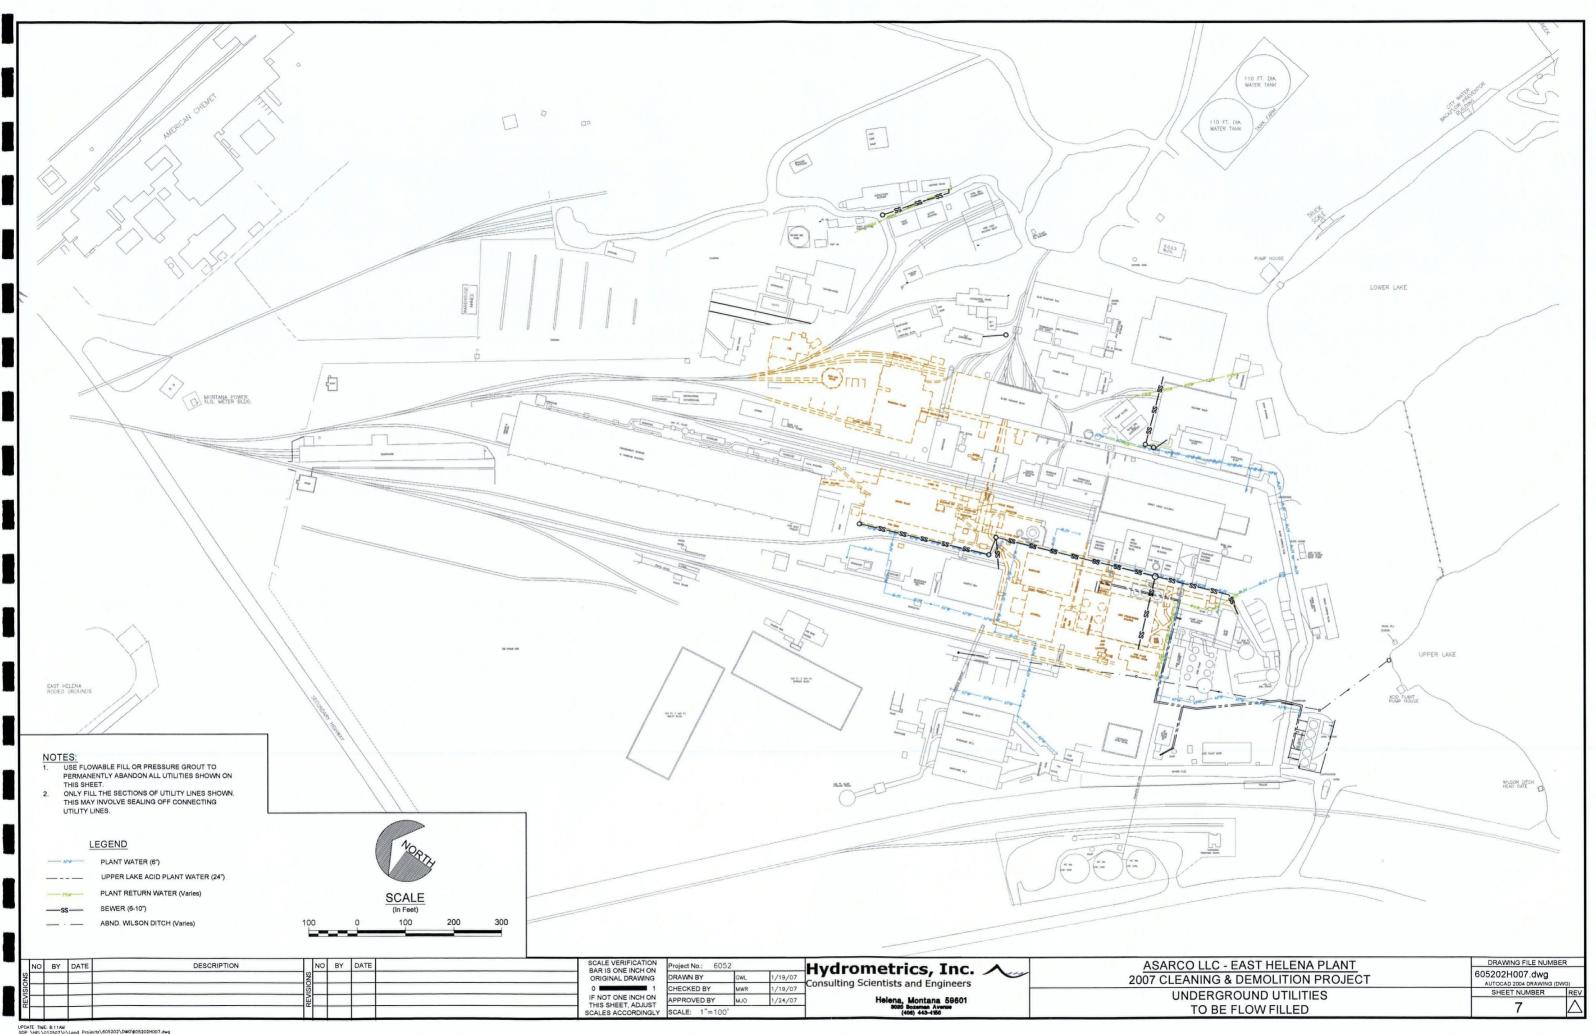













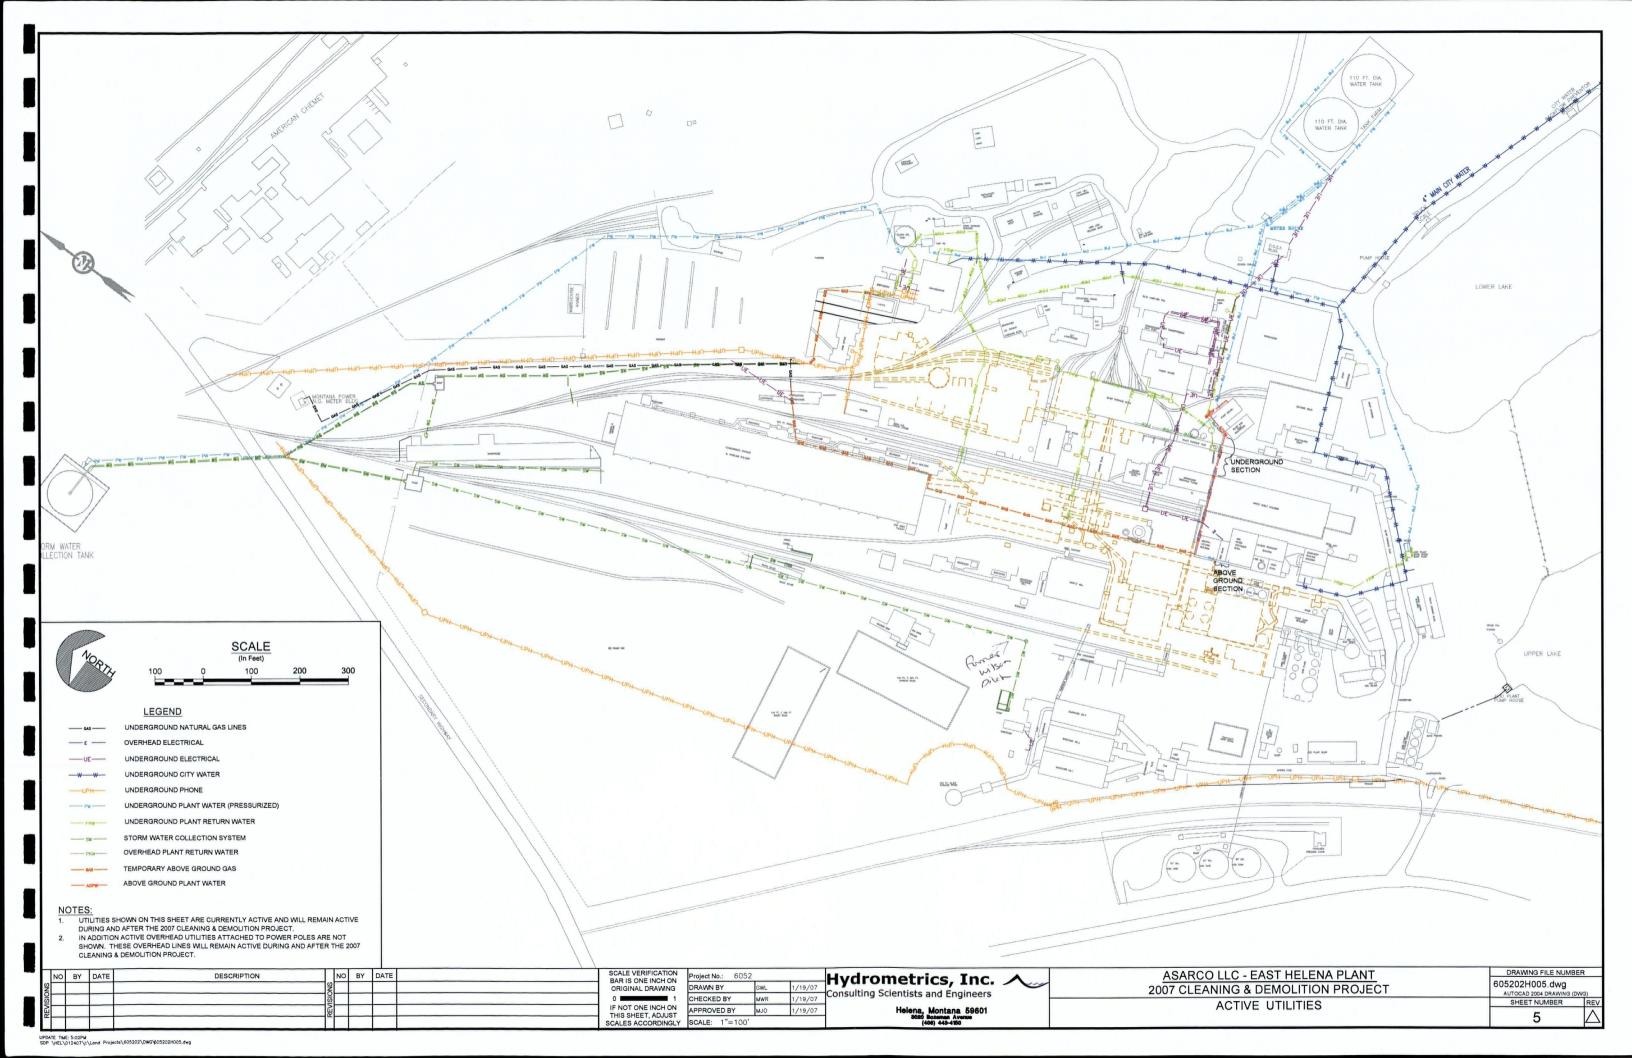

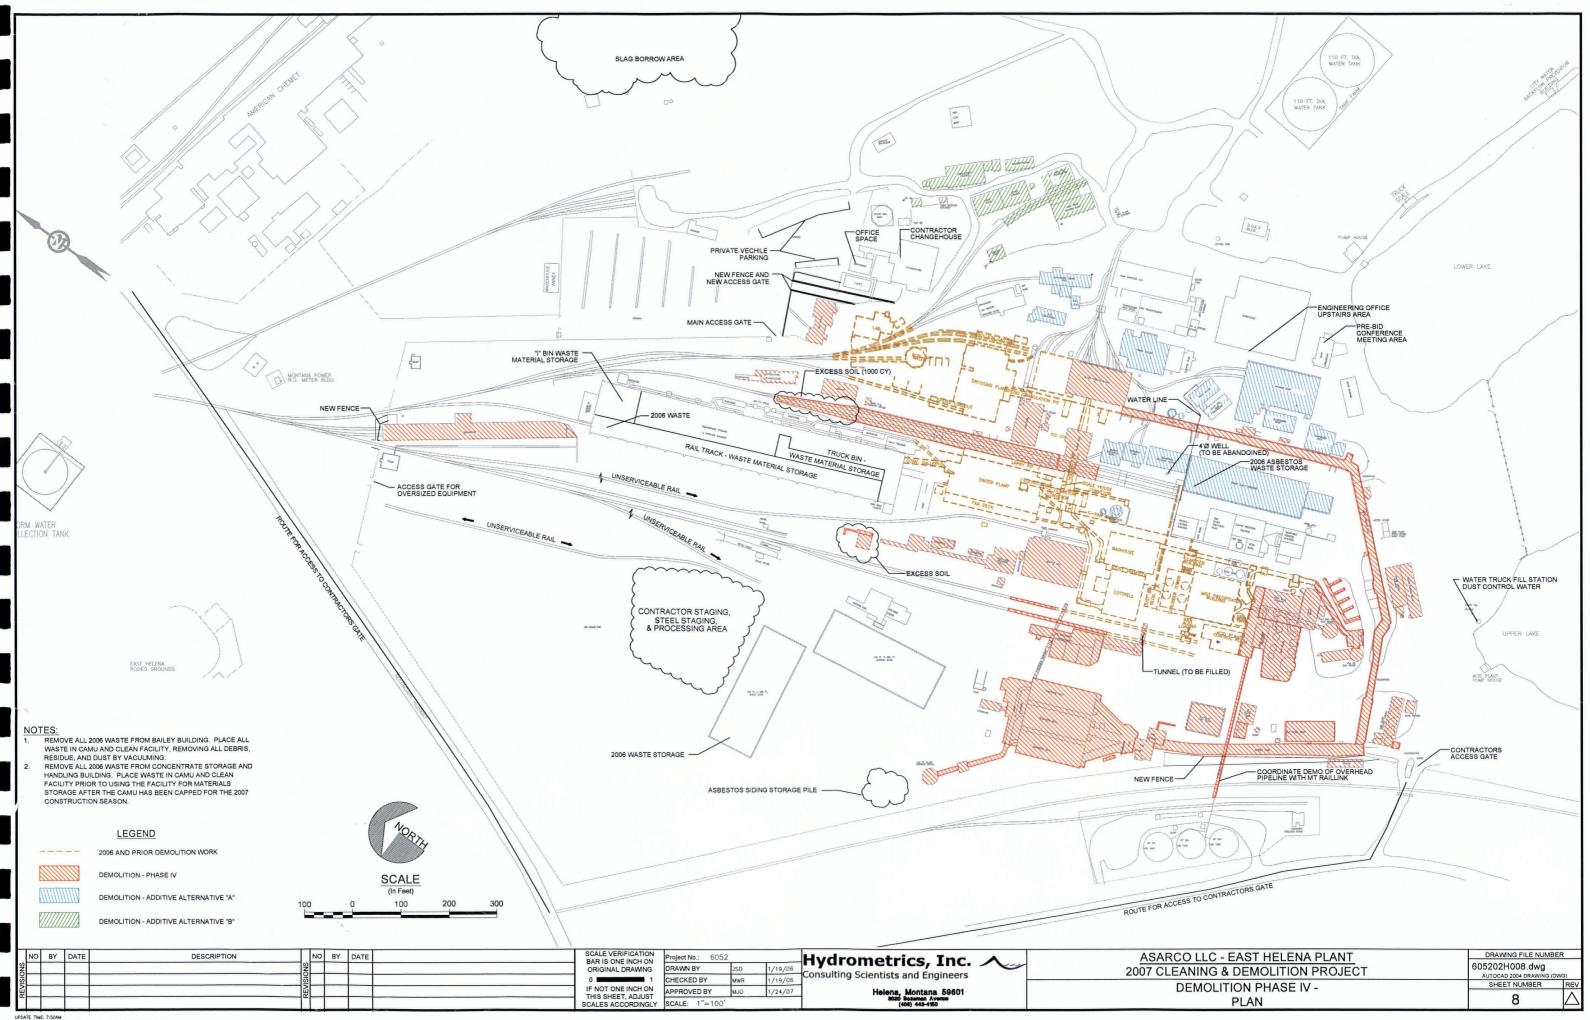

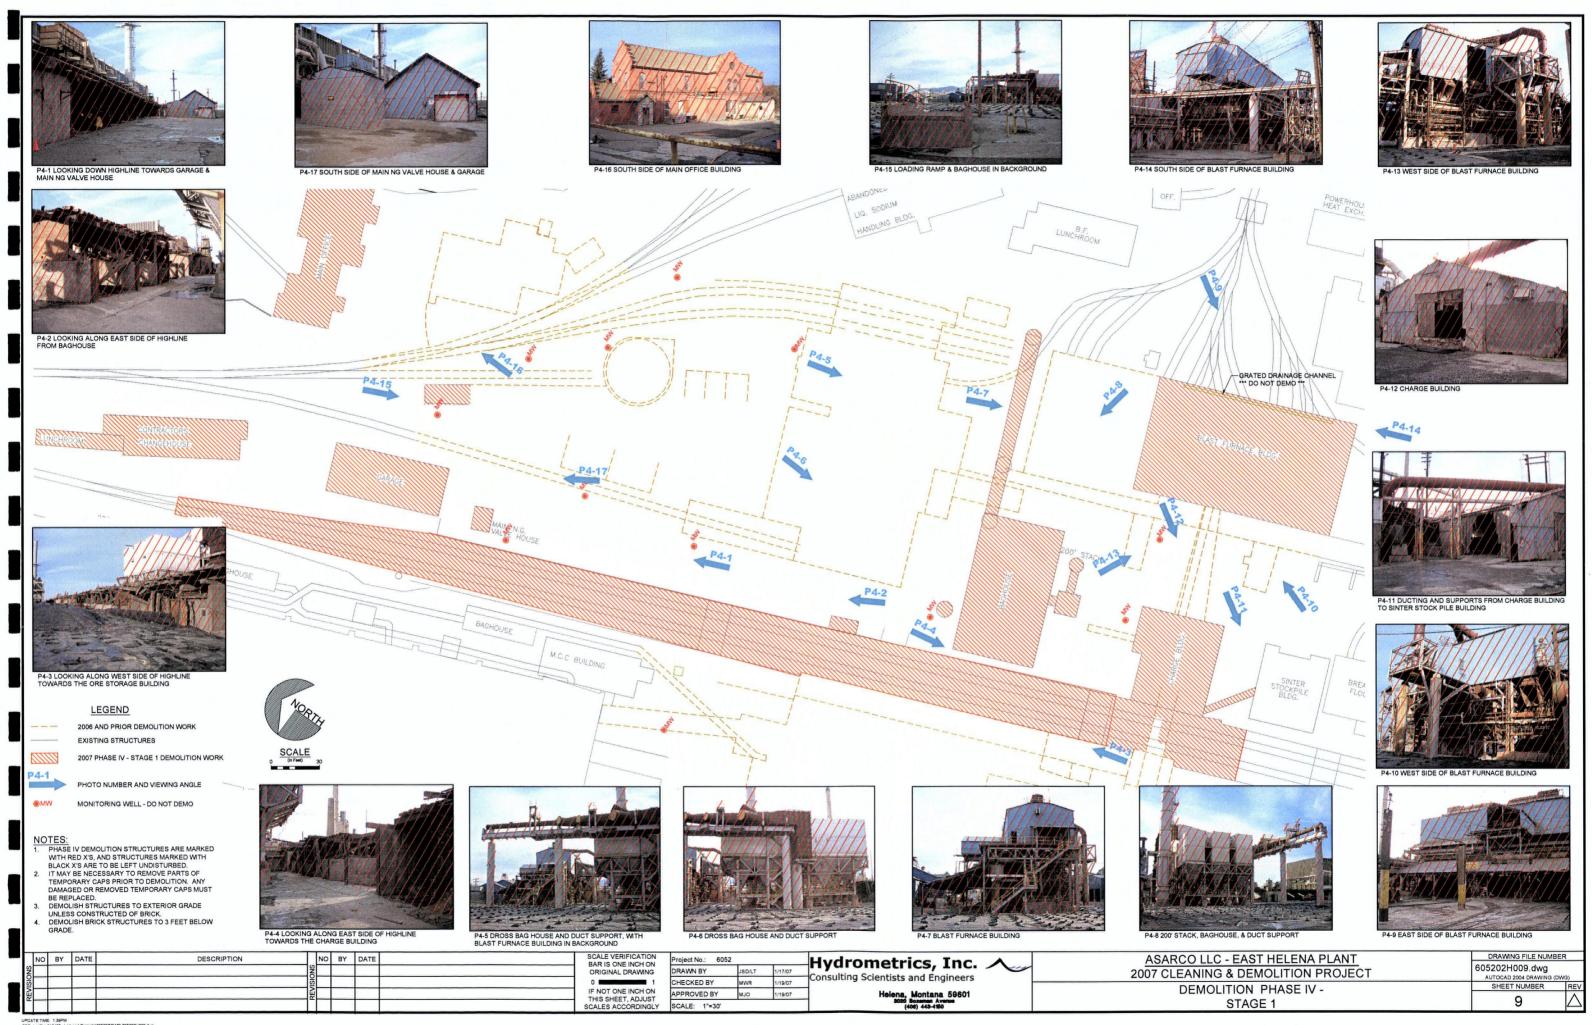

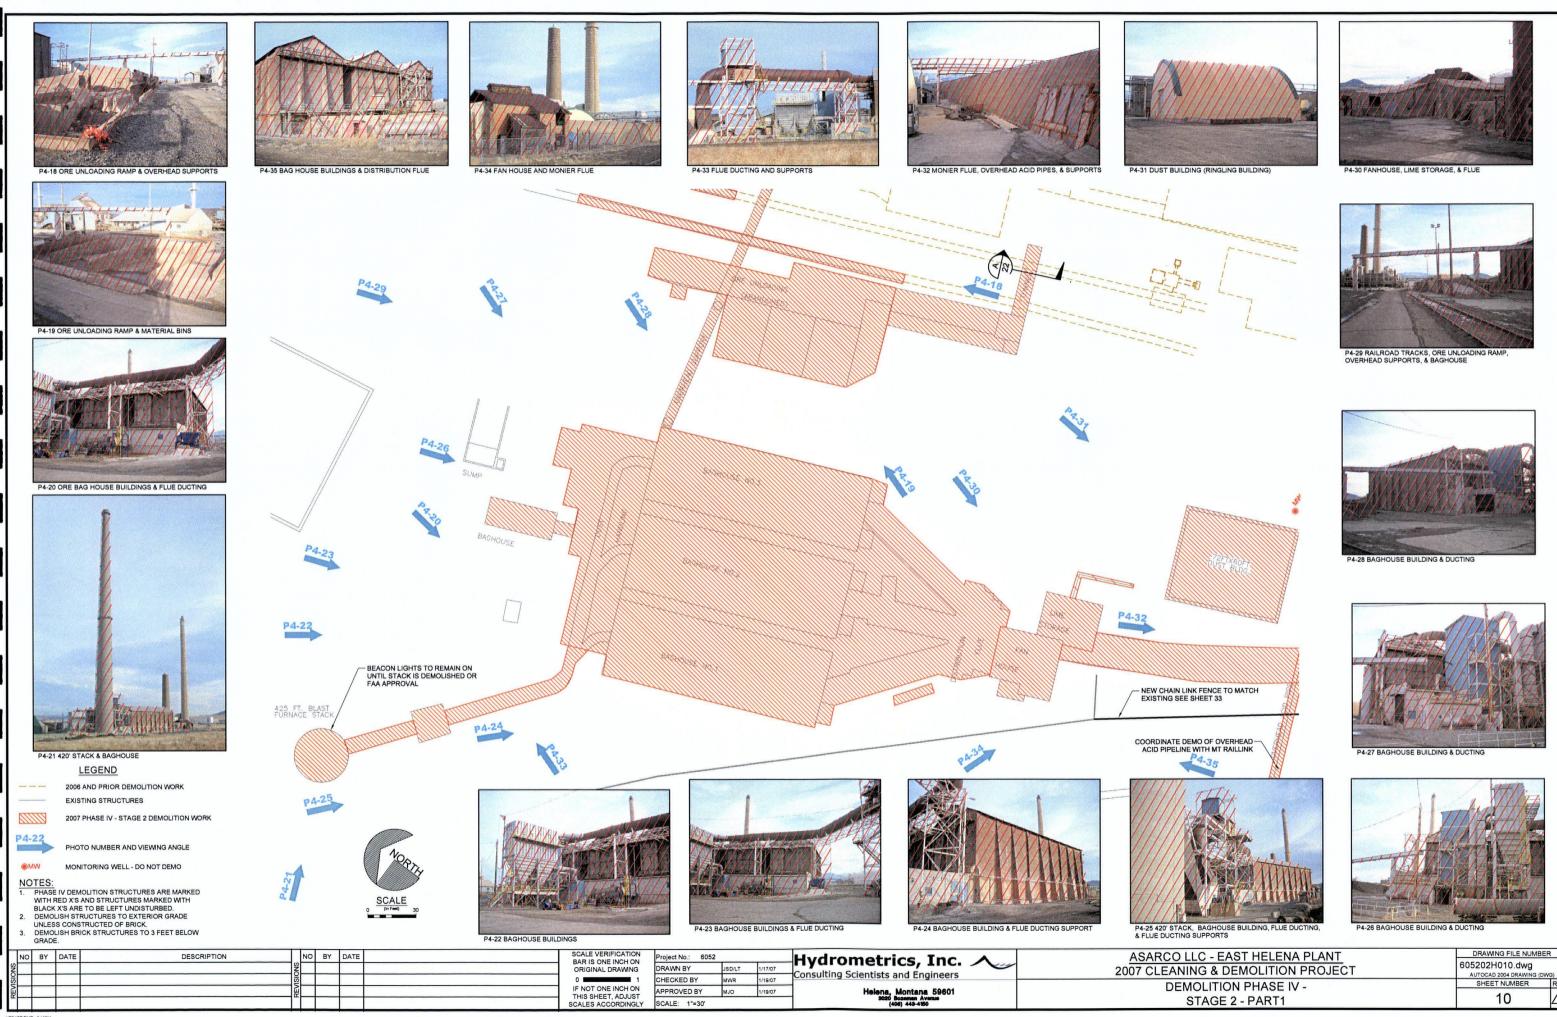





P4-37 ACID PLANT COOLING TOWERS



P4-38 ACID PLANT, MAIN BLOWER BUILDING, & STACKS



P4-39 ACID DECOLOR BUILDING & OVERHEAD ACID PIPELINE

#### LEGEND

2006 AND PRIOR DEMOLITION WORK

EXISTING STRUCTURES

2007 PHASE IV - STAGE 2 DEMOLITION WORK




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NOTES:

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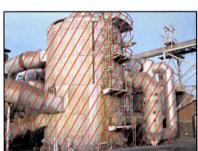
- UNDISTURBED.
  IT MAY BE NECESSARY TO REMOVE PARTS OF TEMPORARY CAPS PRIOR TO DEMOLITION. ANY DAMAGED OR REMOVED TEMPORARY CAPS MUST BE REPLACED.
  DEMOLISH STRUCTURES TO EXTERIOR GRADE UNLESS CONSTRUCTED OF BRICK.
  DEMOLISH BRICK STRUCTURES TO 3 FEET BELOW GRADE.






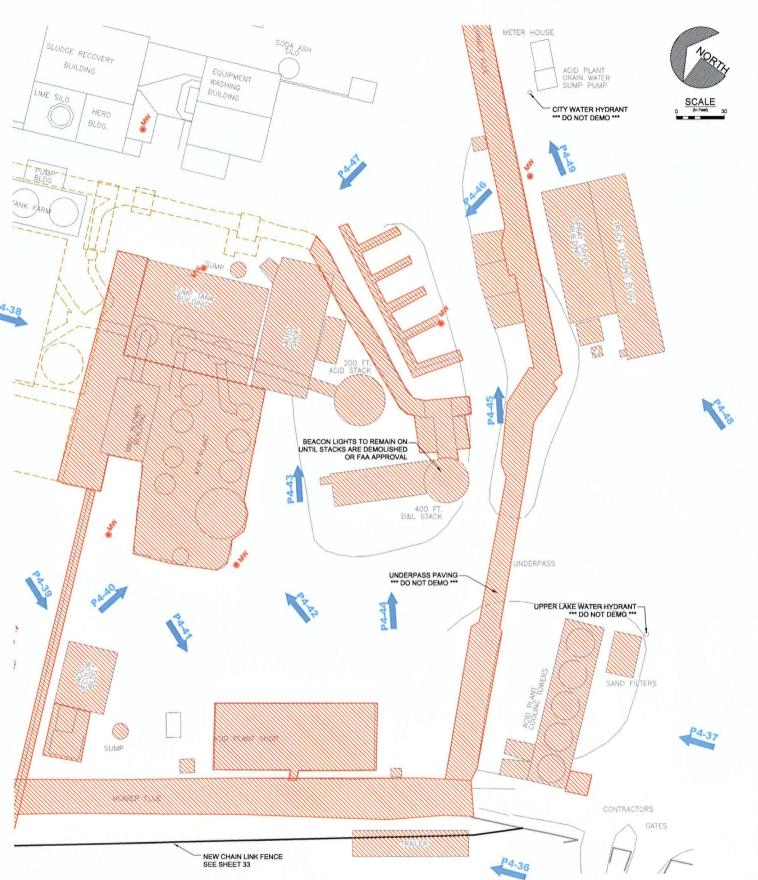

P4-41 ACID PLANT SHOP



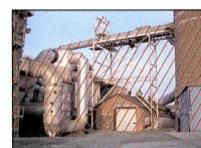

P4-43 ACID PLANT, AUTO SHOP, & 200' STACK



P4-44 STORAGE BUILDING, 200' STACK, & 400' STACK





P4-46 MATERIAL STORAGE BINS



P4-47 ACID PLANT AND PIPING



P4-48 SPRAY DRYER BUILDING & TRUCK LOADING BUILDING




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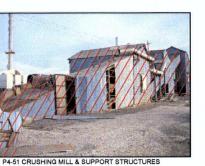
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Hydrometrics, Inc. 🔨 onsulting Scientists and Engineers

ASARCO LLC - EAST HELENA PLANT 2007 CLEANING & DEMOLITION PROJECT **DEMOLITION PHASE IV -**STAGE 2 - PART 2


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P4-52 WEST SIDE OF CRUSHING MILL



LEGEND

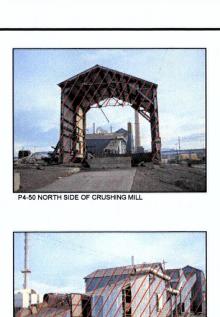2006 AND PRIOR DEMOLITION WORK EXISTING STRUCTURES


2007 PHASE IV - STAGE 1 & 2 DEMOLITION WORK

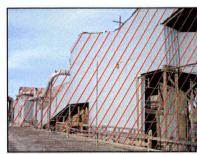

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- OTES:
  PHASE IV DEMOLITION STRUCTURES ARE MARKED WITH RED
  X'S AND STRUCTURES MARKED WITH BLACK X'S ARE TO BE
  LEFT UNDISTURBED.
  IT MAY BE NECESSARY TO REMOVE PARTS OF TEMPORARY
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  TEMPORARY CAPS MUST BE REPLACED.
  DEMOLISH STRUCTURES TO EXTERIOR GRADE UNLESS
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  DEMOLISH BRICK STRUCTURES TO 3 FEET BELOW GRADE.

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P4-55 SAMPLE MILL

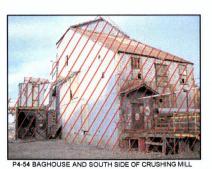

P4-56 SOUTH SIDE OF SAMPLE MILL

1/19/07



-EXISTING CONCRETE DRAINAGE DITCH

P4-57 EAST SIDE OF SAMPLE MILL & DUST LOAD OUT



EXISTING RETAINING WALL
\*\*\* DO NOT DEMO \*\*\*











NEW CHAIN LINK FENCE — SEE SHEET 33



CRUSHING & SAMPLE MILL - STAGE 2 DEMOLITION

THAWHOUSE - STAGE 1 DEMOLITION


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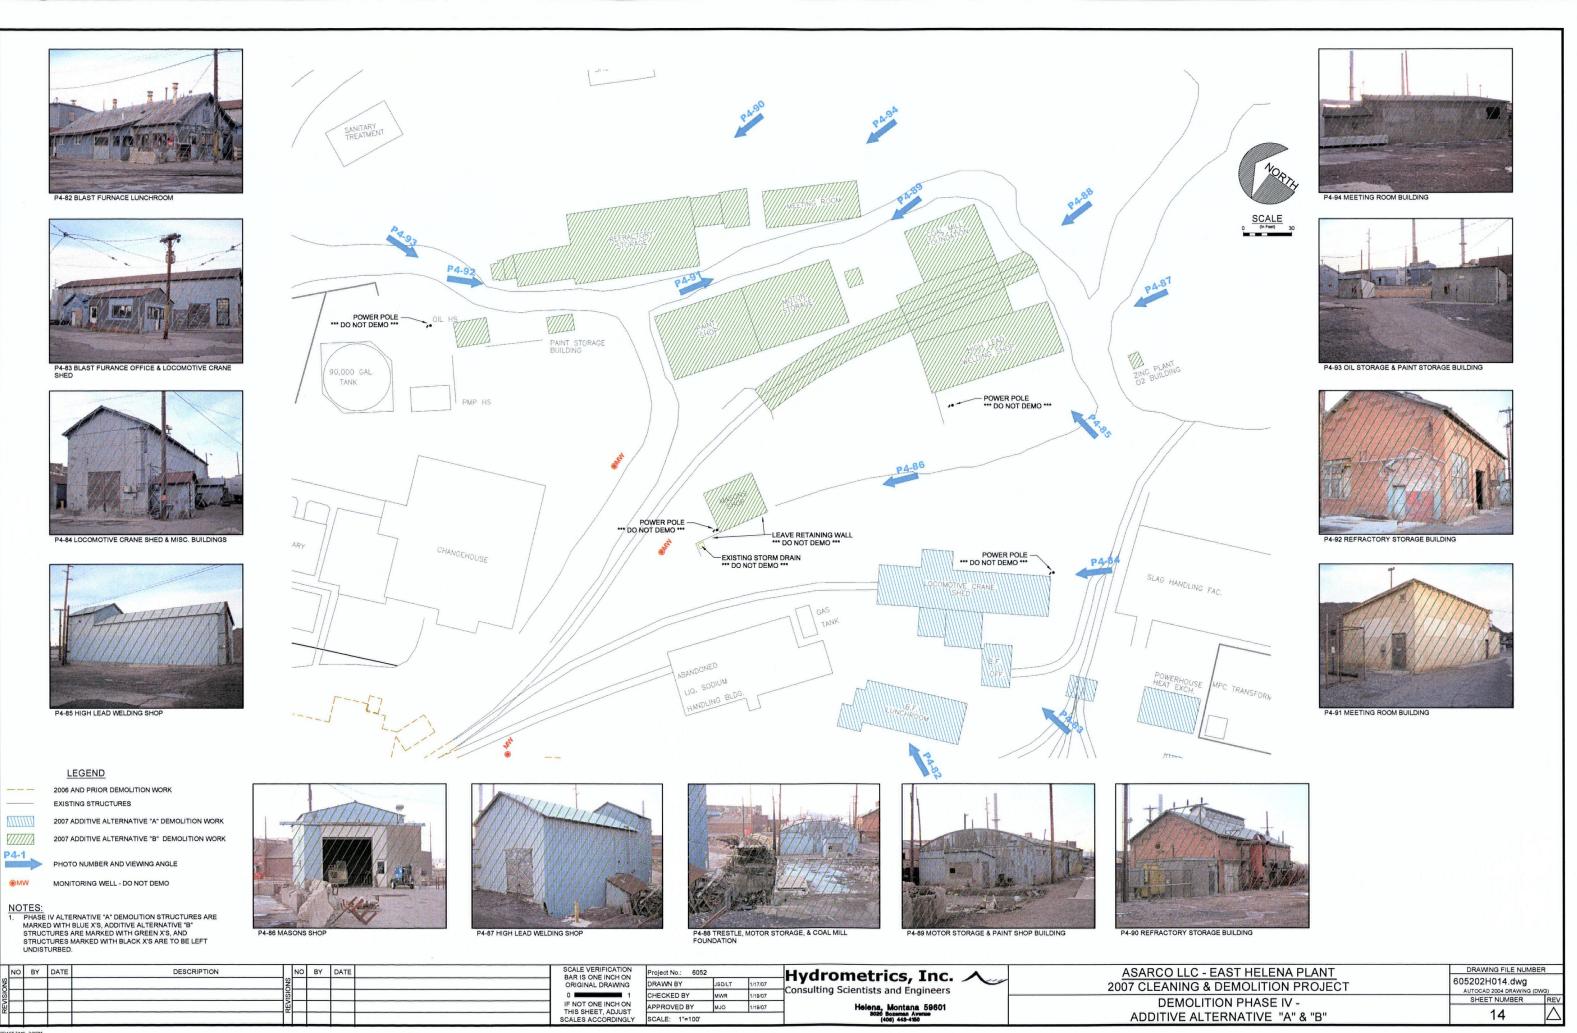
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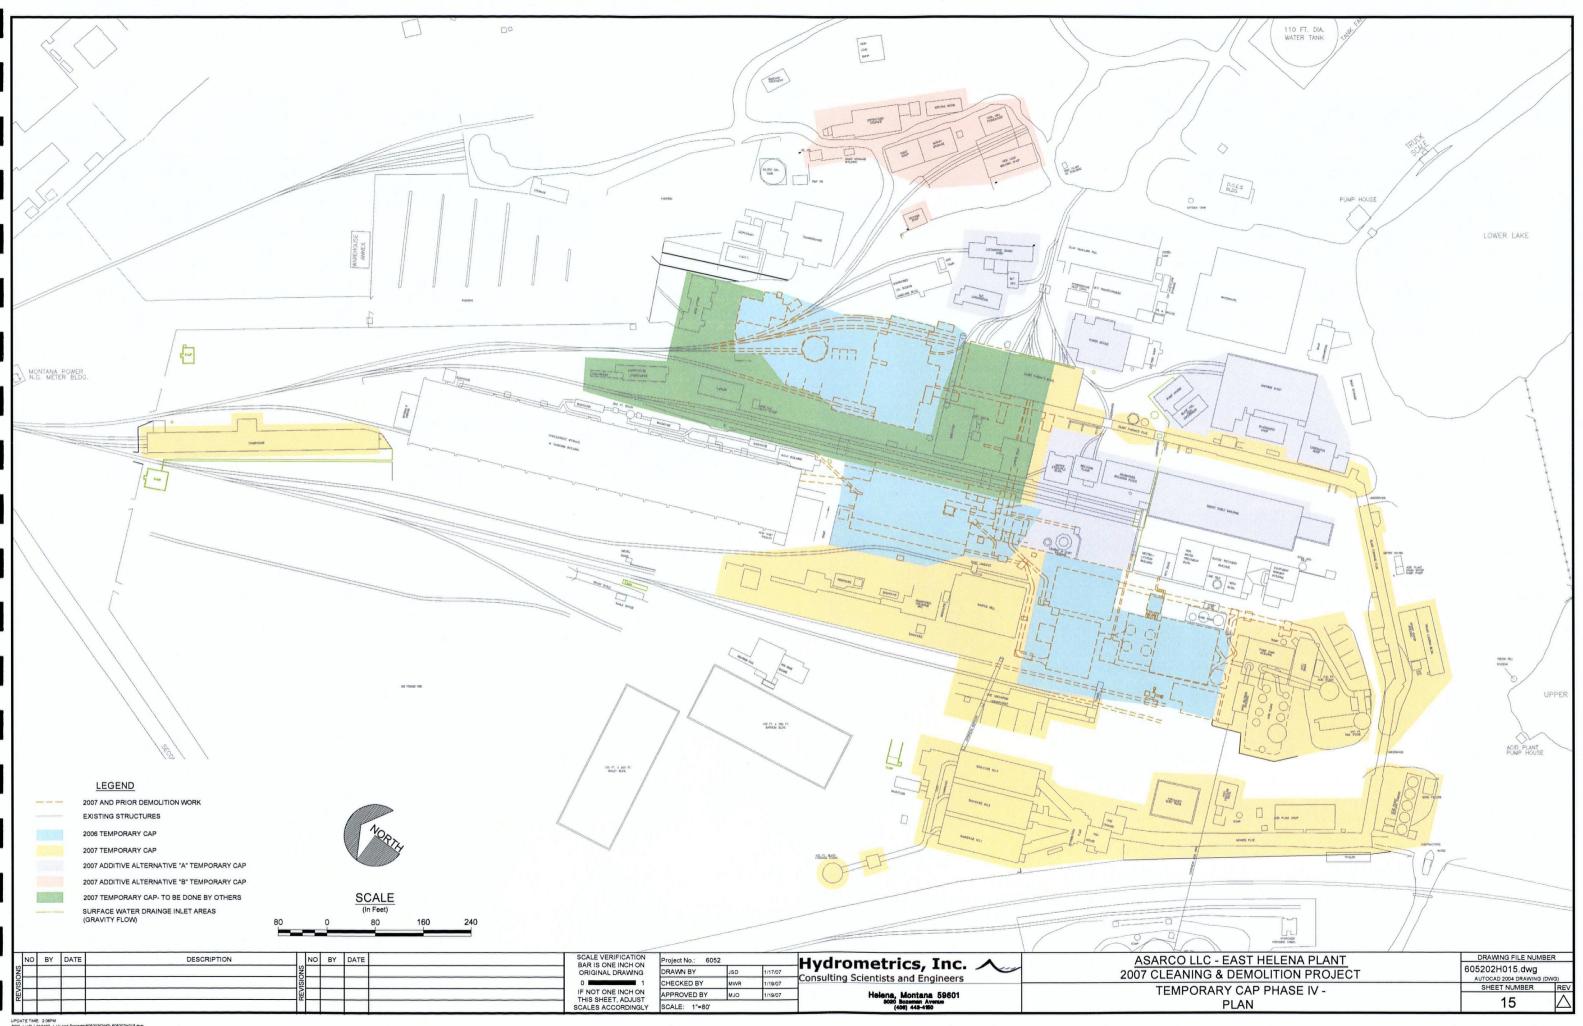
HAWHOUSE INCLUDES: 6 GONDALES, 1 FLAT CAR, &-1-45' GE LOCOMOTIVE TO BE INCLUDED IN DEMO

ASARCO LLC - EAST HELENA PLANT	
2007 CLEANING & DEMOLITION PROJECT	
DEMOLITION PHASE IV -	•
STAGE 1 & STAGE 2	


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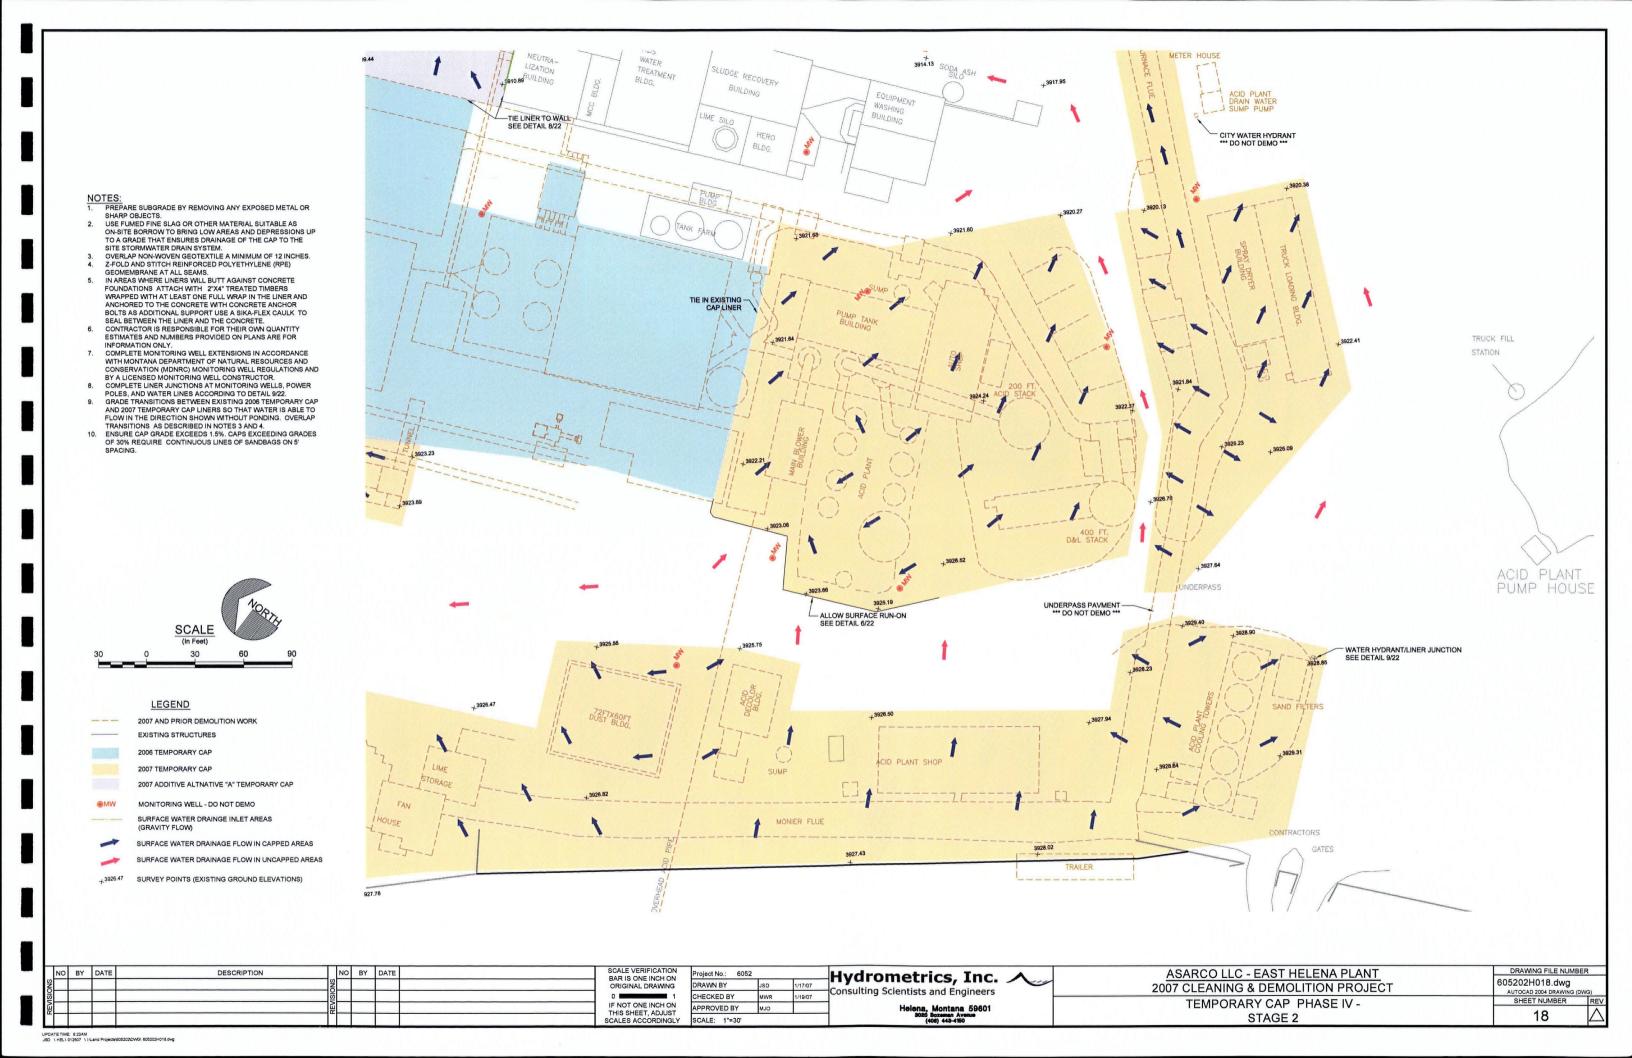







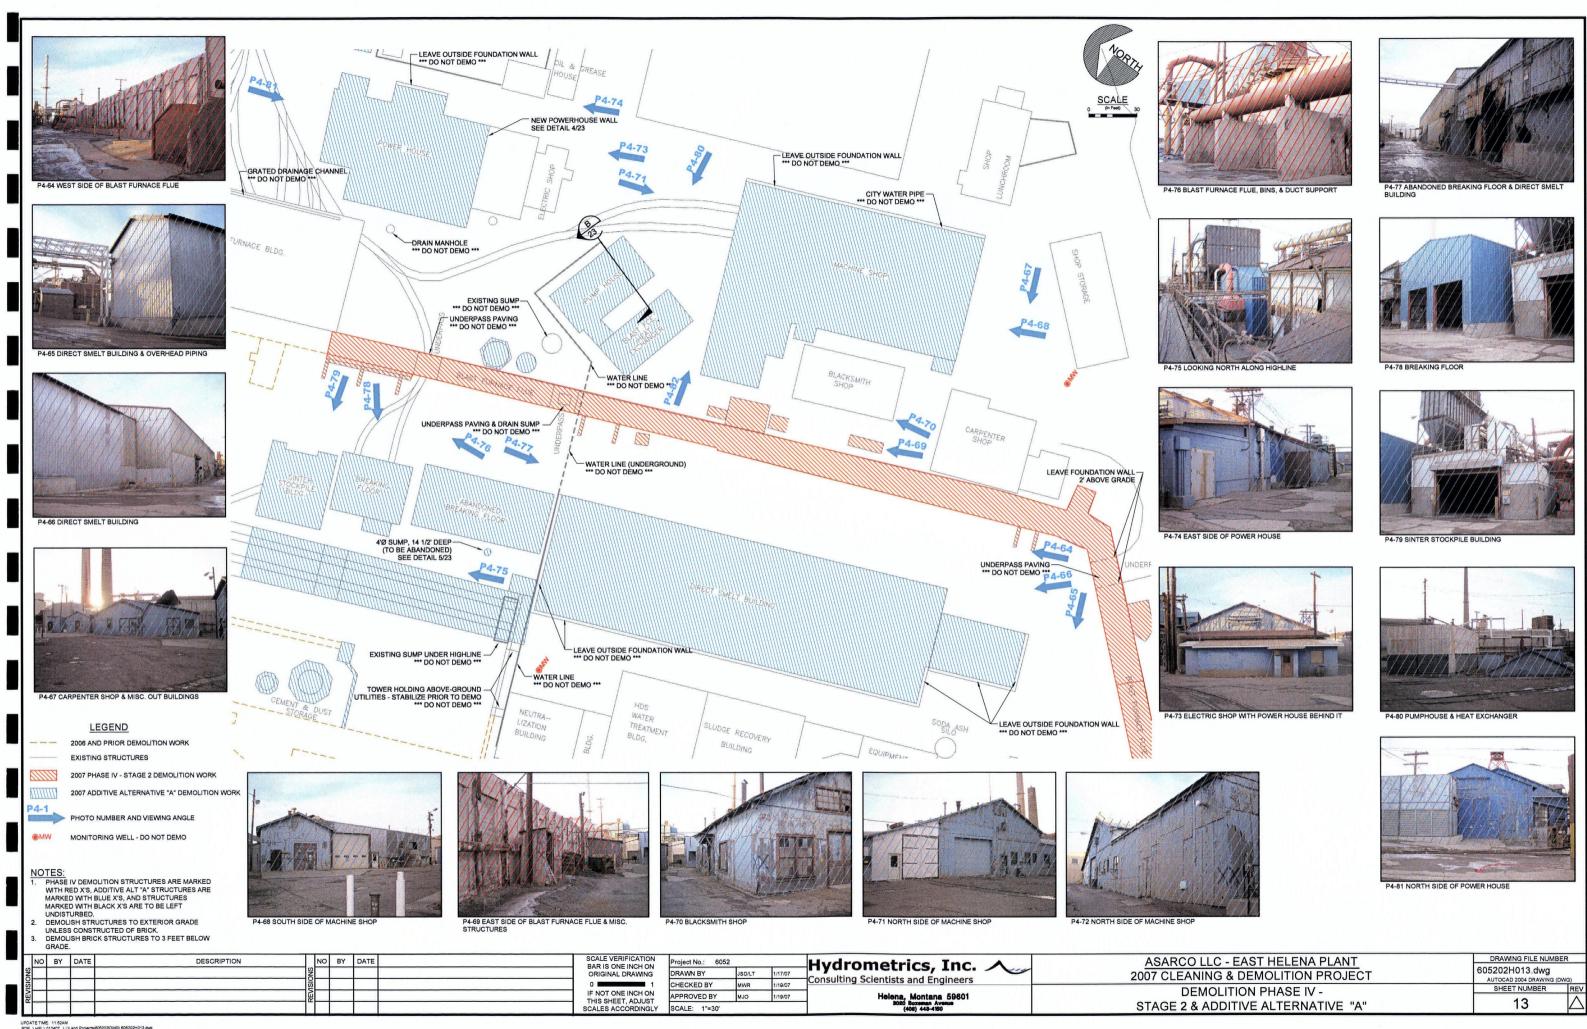



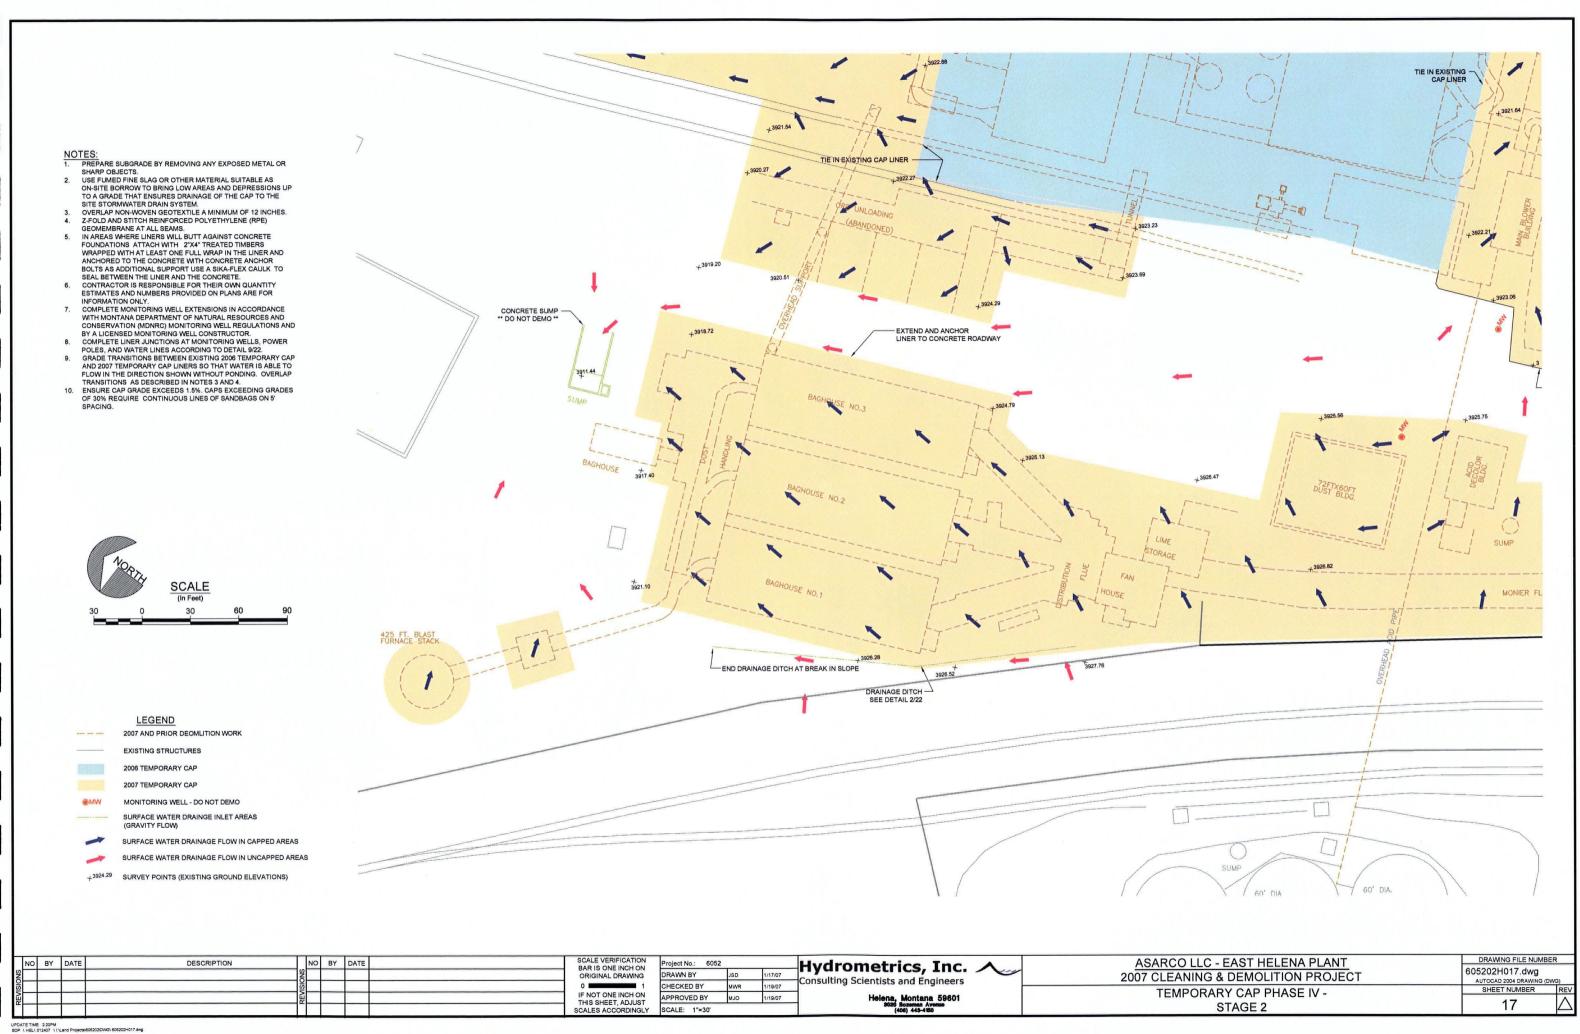


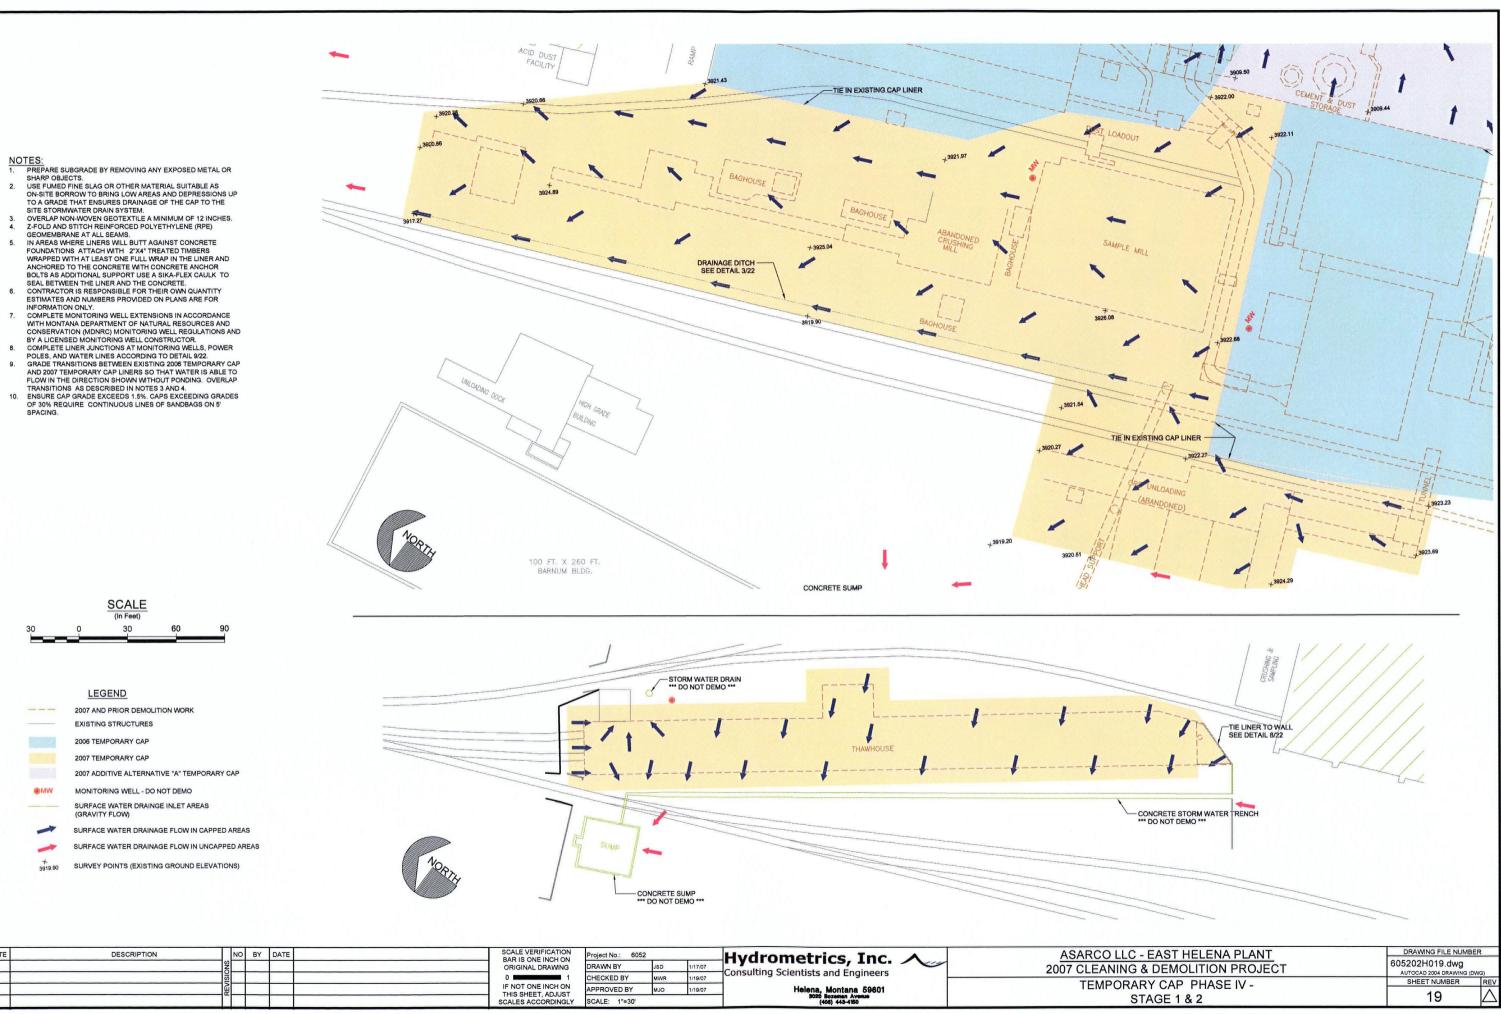

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### TIE LINER TO WALL SEE DETAIL 8/22 —TIE LINER TO WALL SEE DETAIL 8/22 TIE LINER TO WALL SEE DETAIL 8/22 TIE DRAINAGE INTO EXISTING SUMPS 3908.09 -CITY WATER PIPE LINER JUNCTION SEE DETAIL 9/22 WATER LINE/LINER JUCTION SEE DETAIL 9/22 WHITE PLANT WATER LINE INFORMATION ONLY. NEFORMATION ONLY. COMPLETE MONITORING WELL EXTENSIONS IN ACCORDANCE WITH MONTANA DEPARTMENT OF NATURAL RESOURCES AND CONSERVATION (MDNRC) MONITORING WELL RESOURCES AND CONSERVATION (MDNRC) MONITORING WELL CONSTRUCTOR. COMPLETE LINER JUNCTIONS AT MONITORING WELLS, POWER POLES, AND WATER LINES ACCORDING TO DETAIL 9/22. GRADE TRANSITIONS BETWEEN EXISTING 2006 TEMPORARY CAP AND 2007 TEMPORARY CAP LINERS SO THAT WATER IS ABLE TO FLOW IN THE DIRECTION SHOWN WITHOUT PONDING, OVERLAP TRANSITIONS AS DESCRIBED IN NOTES 3 AND 4. ENSURE CAP GRADE EXCEEDS 1.5%. CAPS EXCEEDING GRADES OF 30% REQUIRE CONTINUOUS LINES OF SANDBAGS ON 5' SPACING. CONCRETE SUMP. - UNDERPASS PAVING DRAINAGE DITCH " DO NOT DEMO TIE LINER TO WALL SEE DETAIL 8/22 UNDERPASS PAVING \*\*\* DO NOT DEMO \*\*\* REGRADE AND TH TIE LINER TO WALL SEE DETAIL 8/22 EXISTING SUMP UNDER HIGHLINE TIE LINER TO WALL WATER LUDGE RECOVERY TIE LINER TO WALL SEE DETAIL8/22 CITY WATER HYDRANT SCALE VERIFICATION BAR IS ONE INCH ON ORIGINAL DRAWING ASARCO LLC - EAST HELENA PLANT 605202H020.dwg 2007 CLEANING & DEMOLITION PROJECT

- NOTES:
  1. PREPARE SUBGRADE BY REMOVING ANY EXPOSED METAL OR SHARP OBJECTS
- USE FUMED FINE SLAG OR OTHER MATERIAL SUITABLE AS ON-SITE BORROW TO BRING LOW AREAS AND DEPRESSIONS UP TO A GRADE THAT ENSURES DRAINAGE OF THE CAP TO THE
- SITE STORMWATER DRAIN SYSTEM.
  OVERLAP NON-WOVEN GEOTEXTILE A MINIMUM OF 12 INCHES.
  Z-FOLD AND STITCH REINFORCED POLYETHYLENE (RPE)
- GEOMEMBRANE AT ALL SEAMS.
  IN AREAS WHERE LINERS WILL BUTT AGAINST CONCRETE FOUNDATIONS ATTACH WITH 2"X4" TREATED TIMBERS WRAPPED WITH AT LEAST ONE FULL WRAP IN THE LINER AND WRAPPED WITH AT LEAST ONE FULL WRAP IN THE LINER AND ANCHORED TO THE CONCRETE WITH CONCRETE ANCHOR BOLTS AS ADDITIONAL SUPPORT USE A SIKA-FLEX CAULK TO SEAL BETWEEN THE LINER AND THE CONCRETE. CONTRACTOR IS RESPONSIBLE FOR THEIR OWN QUANTITY ESTIMATES AND NUMBERS PROVIDED ON PLANS ARE FOR INFORMATION ONLY.

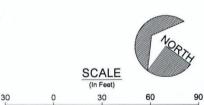

#### LEGEND

2007 AND PRIOR DEMOLITION WORK

EXISTING STRUCTURES

2006 TEMPORARY CAP

2007 ADDITIVE ALTERNATIVE "A" TEMPORARY CAP

2007 ADDITIVE ALTERNATIVE "B" TEMPORARY CAP

2007 TEMPORARY CAP- TO BE DONE BY OTHERS

MONITORING WELL - DO NOT DEMO

SURFACE WATER DRAINGE INLET AREAS (GRAVITY FLOW)

SURFACE WATER DRAINAGE FLOW IN CAPPED AREAS


SURFACE WATER DRAINAGE FLOW IN UNCAPPED AREAS


+3922.11 SURVEY POINTS (EXISTING GROUND ELEVATIONS)


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4	APPROVED BY	мјо	1/19/07	Helena, Montana 59601	
ĹY	SCALE: 1"=30'			3020 Bozemen Avenue (406) 443-4150	


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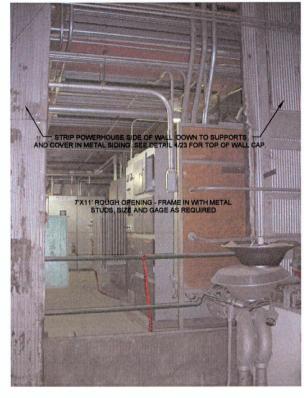


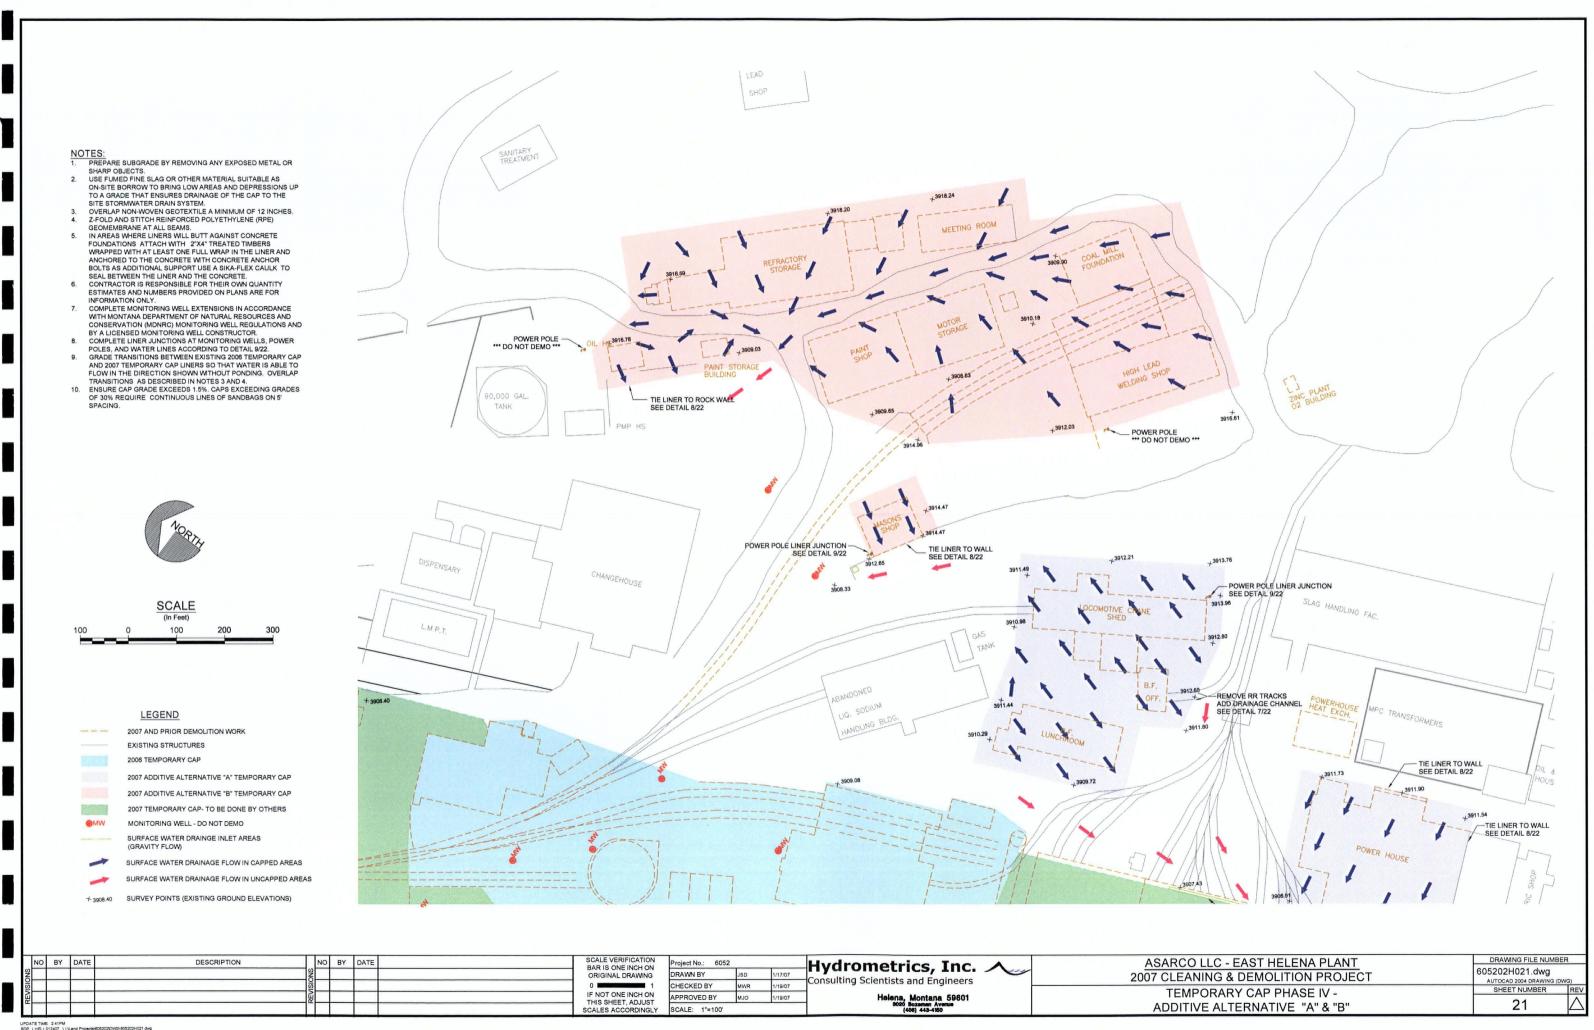

SECTION B PUMP HOUSE ABANDONMENT

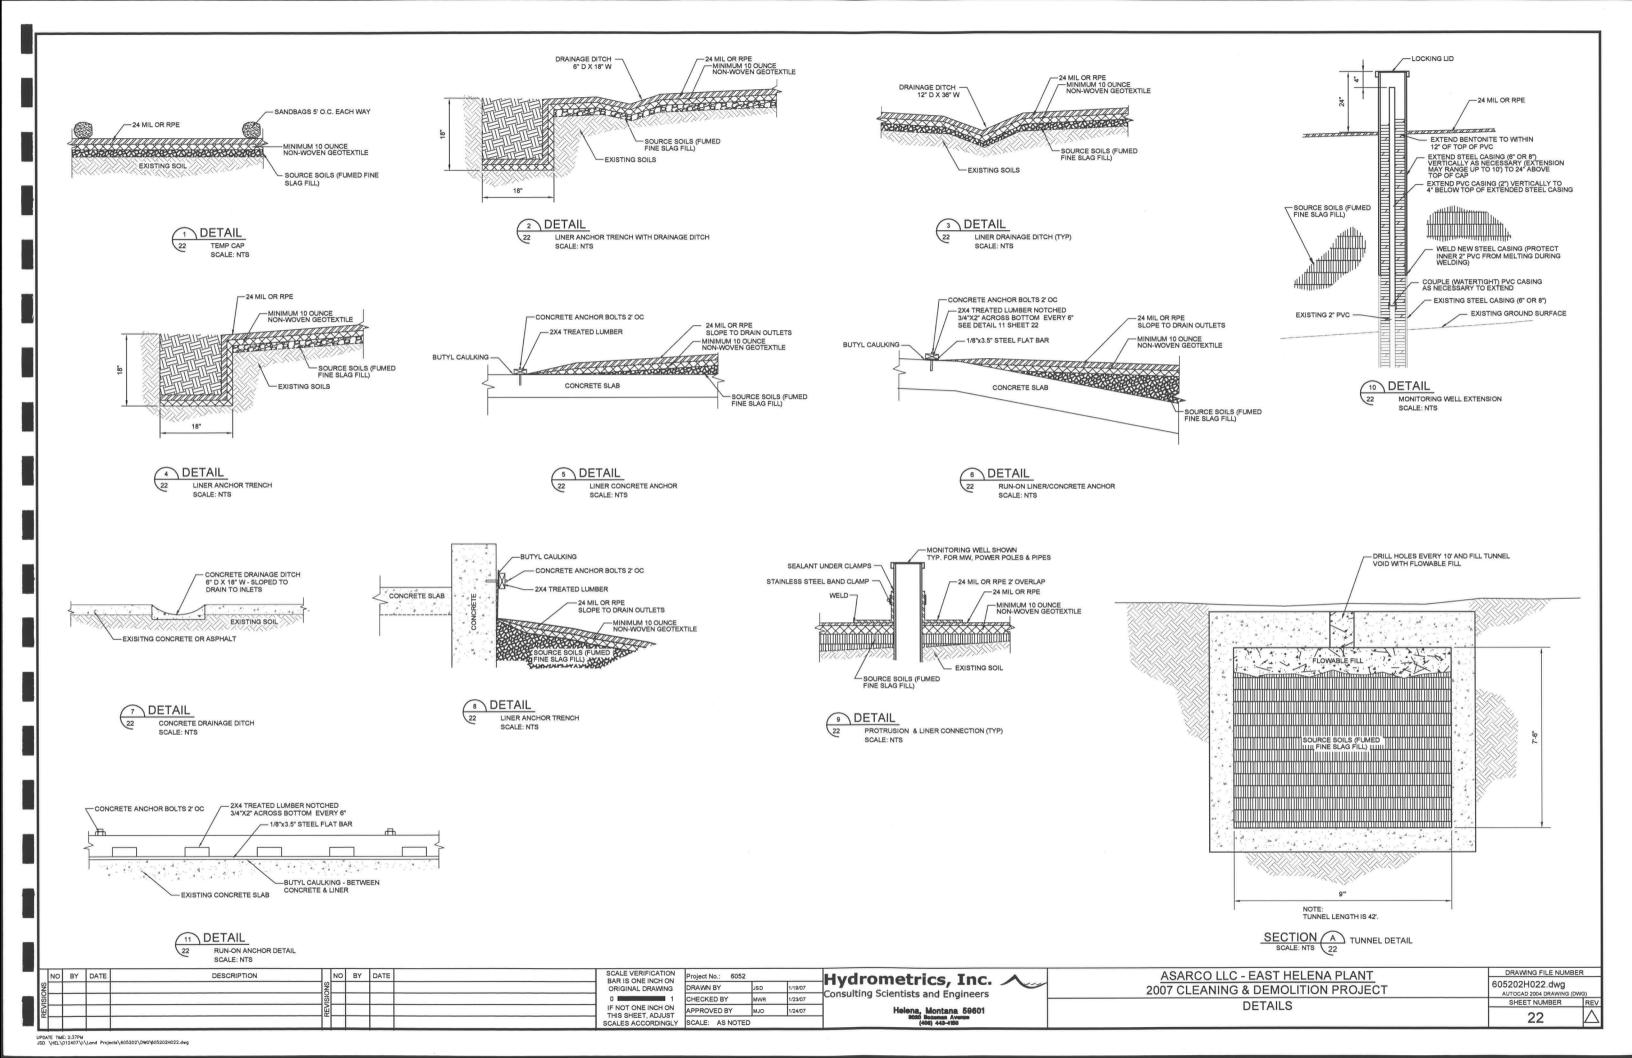

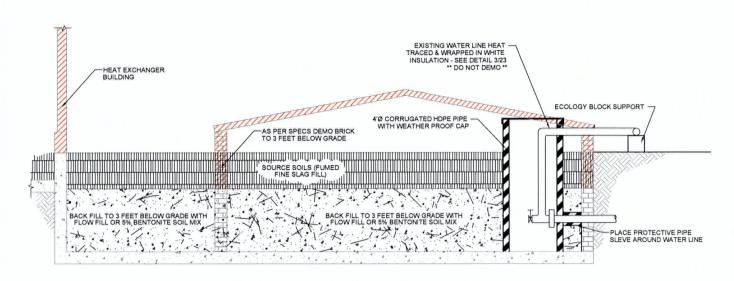

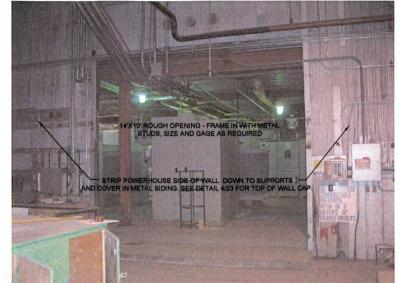

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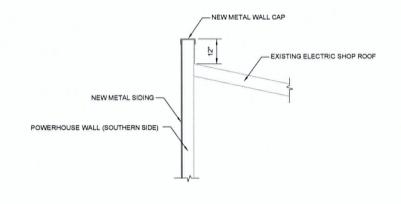
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23



3 DETAIL 23 PUMPHOUS PUMPHOUSE WATER LINE



4 DETAIL POWERHOUSE WALL CAPPING



5 DETAIL 23 4'Ø - 14 1/2' 4'Ø - 14 1/2' DEEP SUMP

BY 14 1/2' DEEP SUMP - DEMOLISH TO GRADE & FILL WITH FLOW FILL


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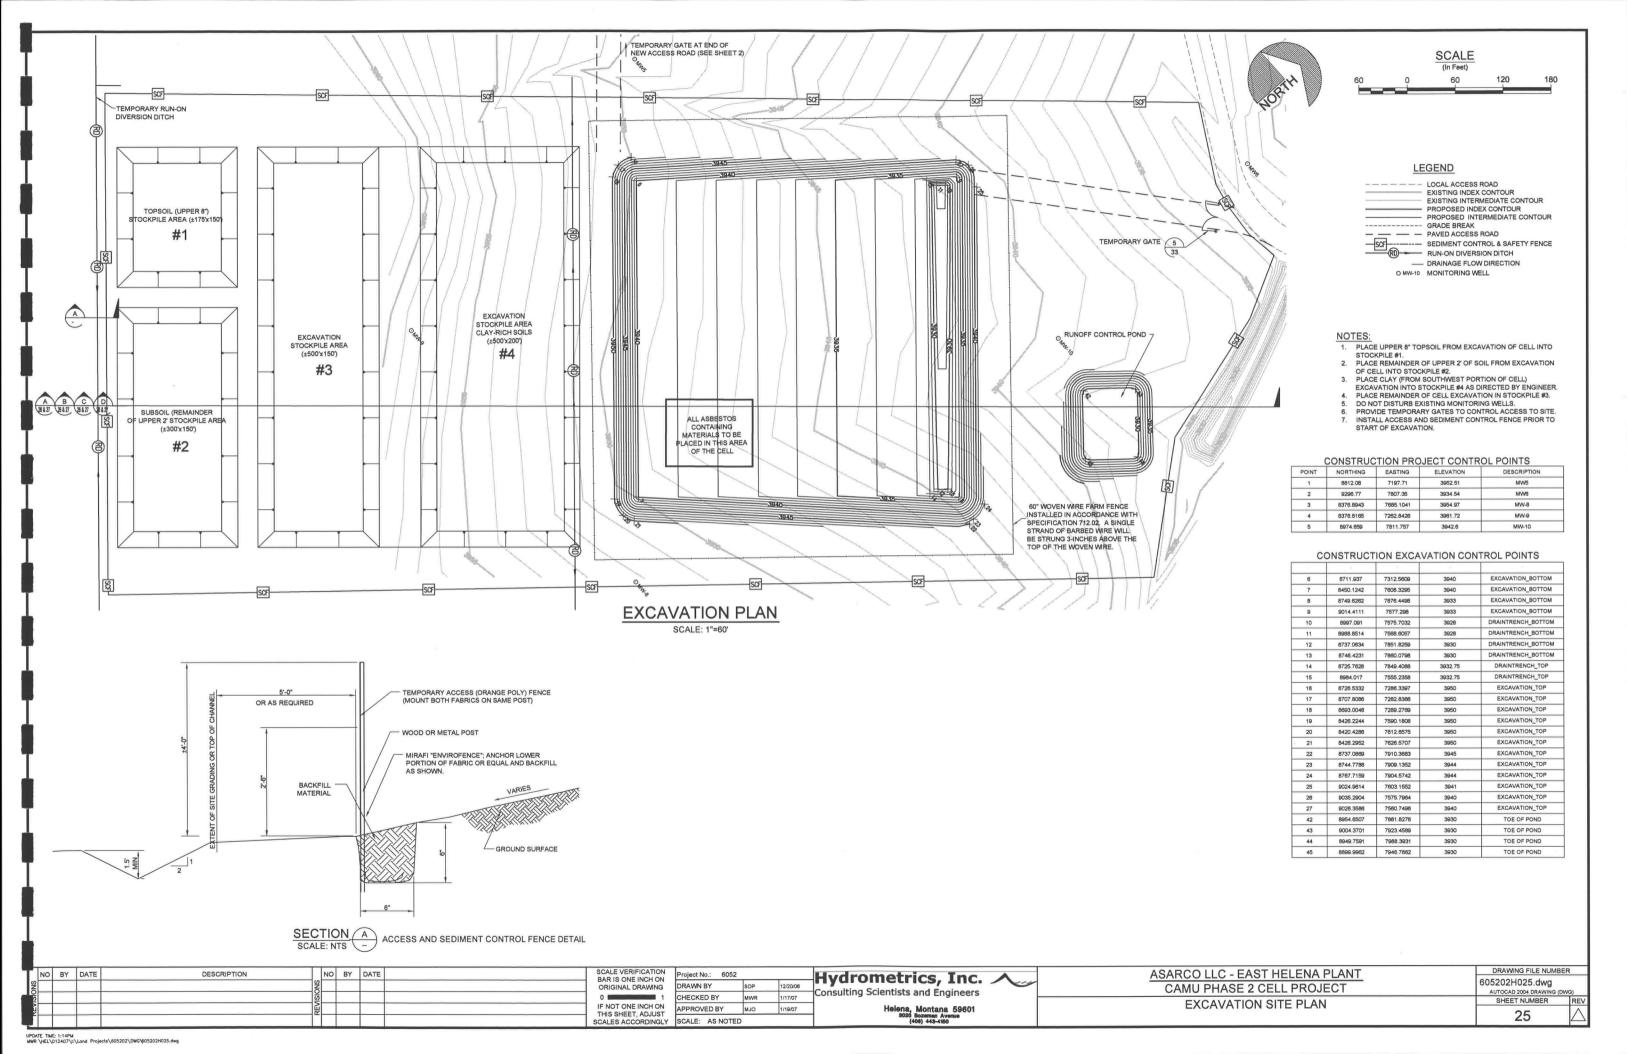
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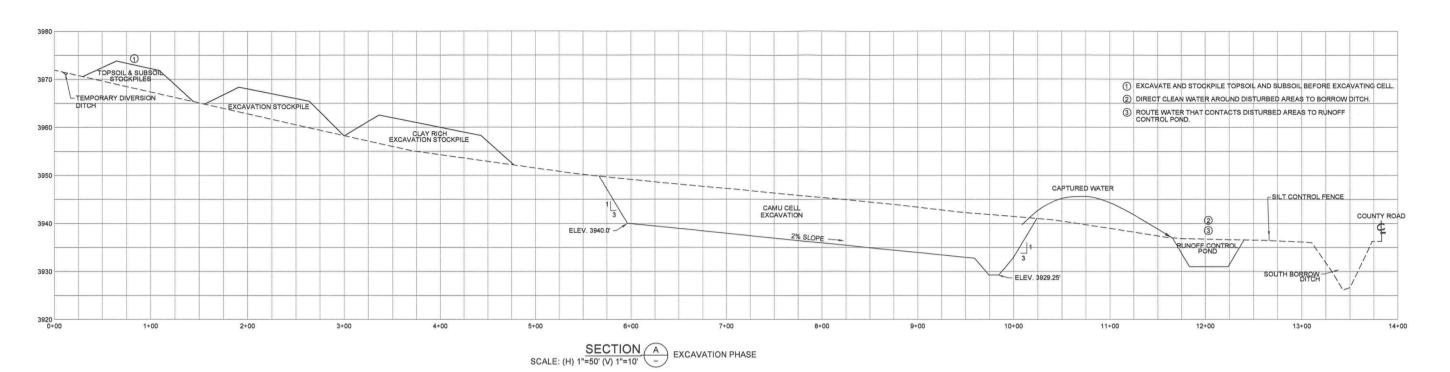
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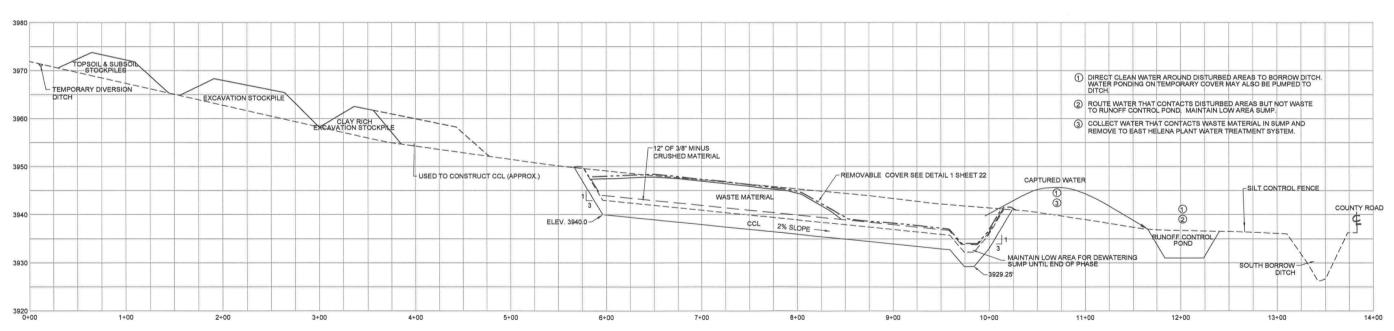
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C - EAST HELENA PLANT
G & DEMOLITION PROJECT
DETAILS
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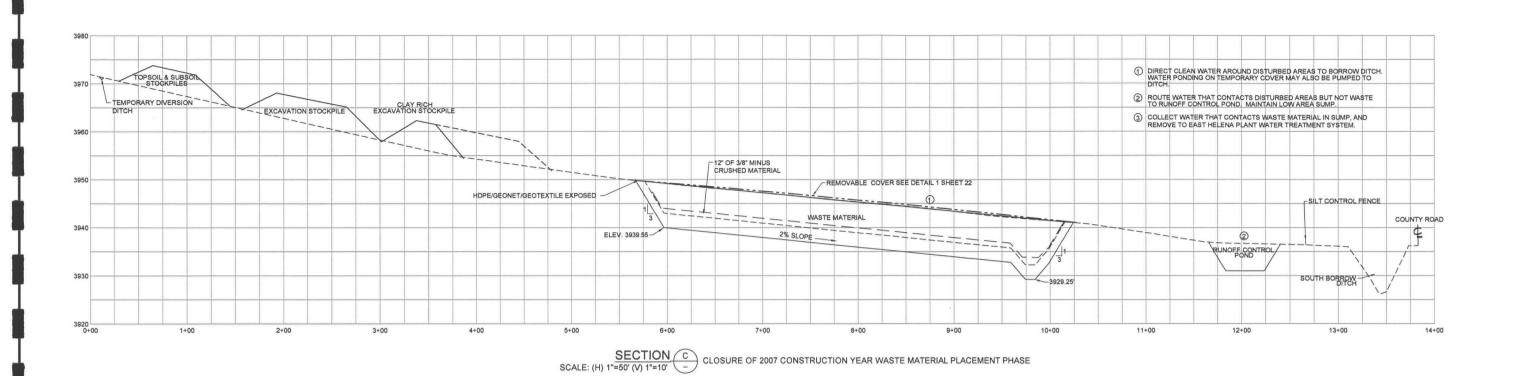









SECTION B DURING INTERMEDIATE WASTE MATERIAL PLACEMENT PHASE SCALE: (H) 1"=50' (V) 1"=10'

NO BY DATE DESCRIPTION NO BY DATE	SCALE VERIFICATION BAR IS ONE INCH ON Project No.: 6052	Hydrometrics, Inc.	ASARCO LLC - EAST HELENA PLANT	DRAWING FILE NUMBE	-R
	ORIGINAL DRAWING DRAWN BY SDP 12/03/08	Consulting Scientists and Engineers	CAMU PHASE 2 CELL PROJECT	605202H026.dwg AUTOCAD 2004 DRAWING (DV	(WG)
	0 1 CHECKED BY MWR 1/17/07  IF NOT ONE INCH ON ADDROVED BY HIGH	- Constituting Constitution and Engineers	EROSION CONTROL PLAN	SHEET NUMBER	REV
	THIS OFFICE ROOF OF APPROVED BY MJO 1/1907  SCALES ACCORDINGLY SCALE: AS NOTED	Helena, Montana 59601 3020 Bozeman Avenue (406) 443-450	WASTE PLACEMENT	26	$\triangle$

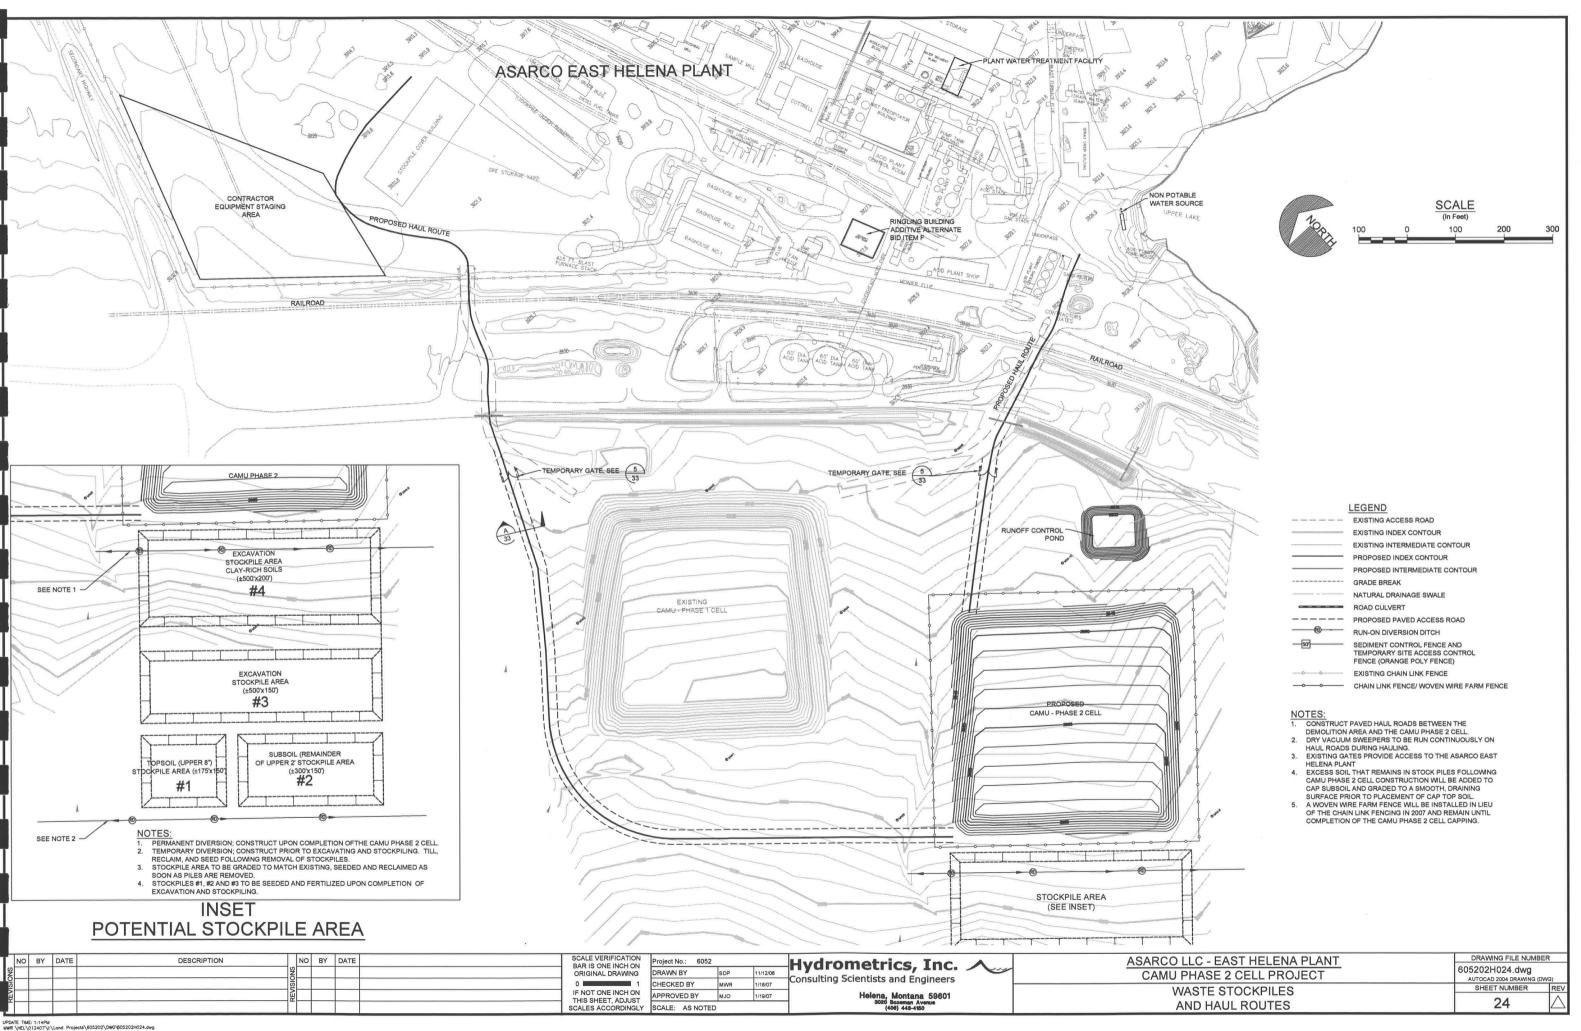

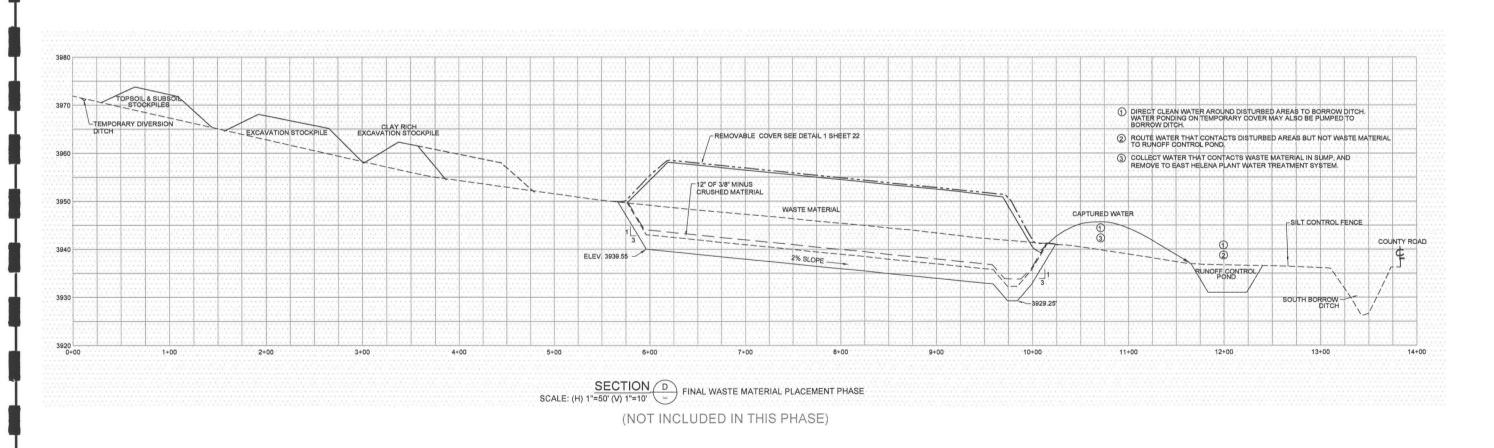

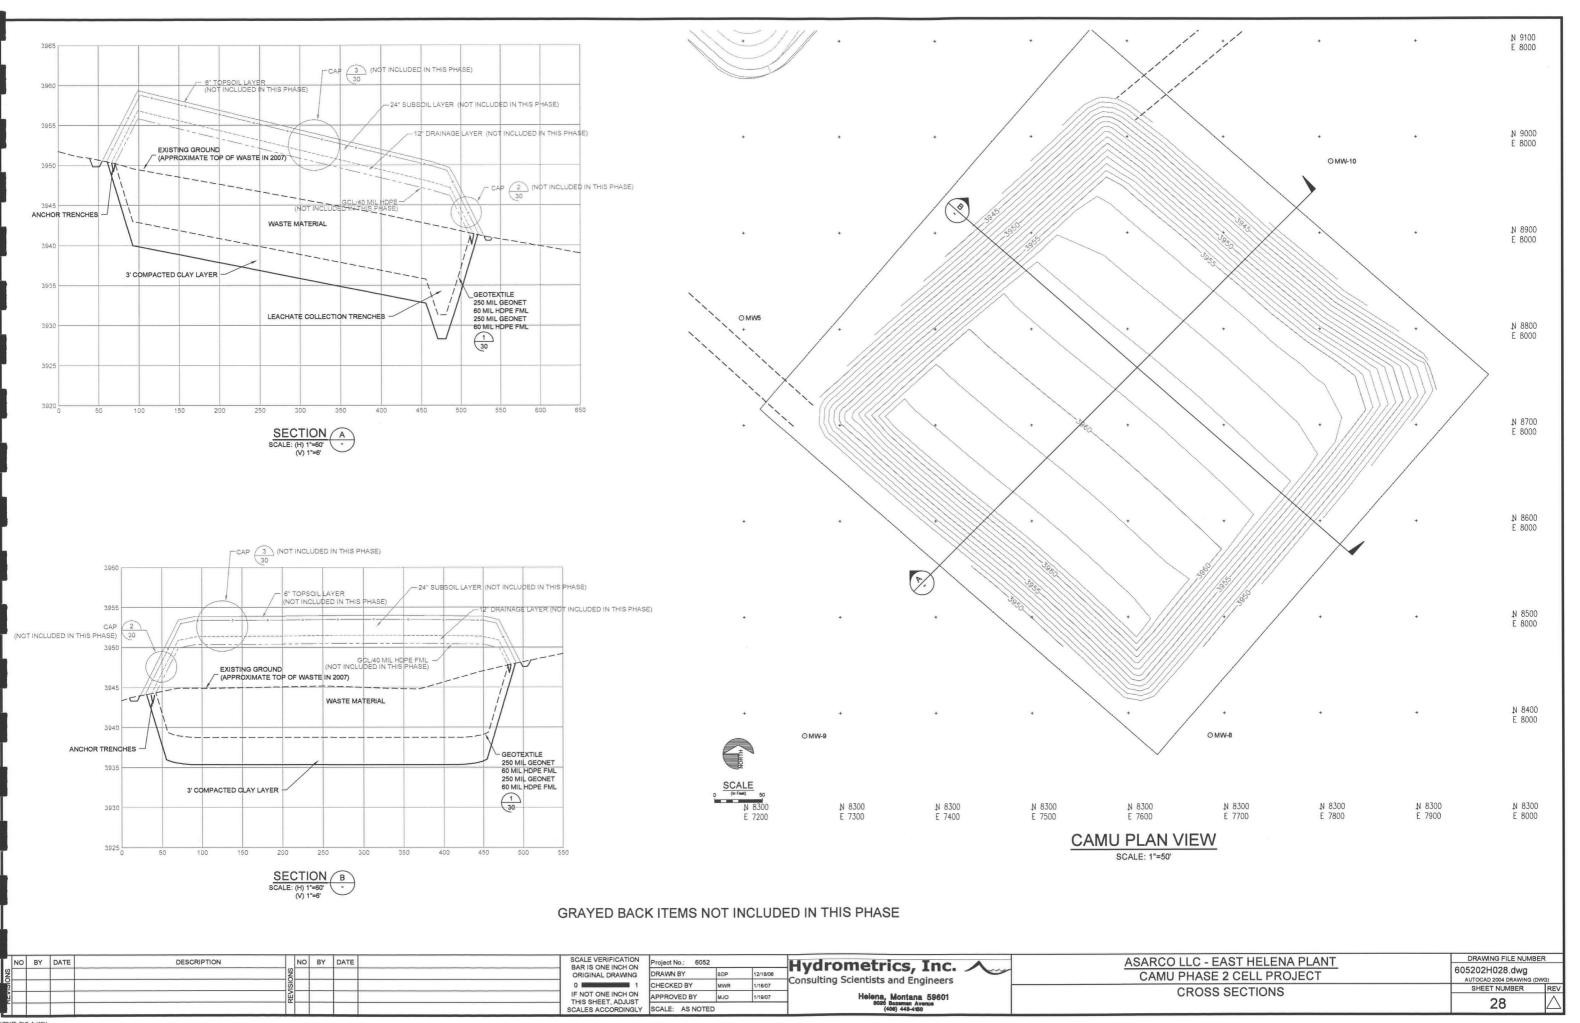


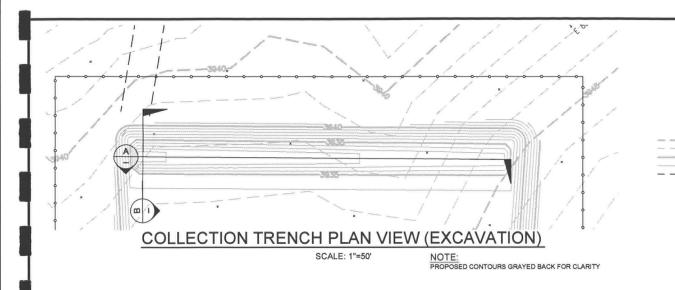






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SCALE VERIFICATION
BAR IS ONE INCH ON
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IF NOT ONE INCH ON
THIS SHEET, ADJUST
SCALES ACCORDINGLY

 Project No.:
 6052

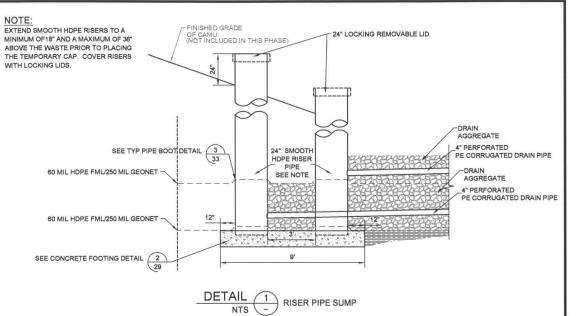 DRAWN BY
 SDP
 12/12/06

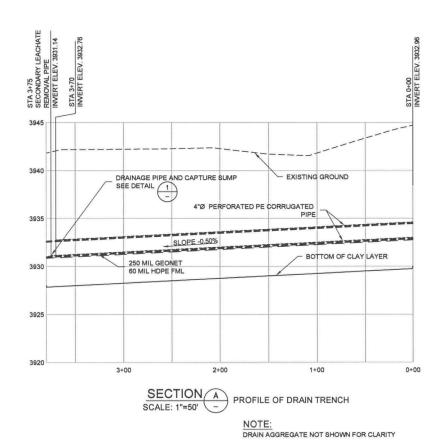 CHECKED BY
 MWR
 1/17/07

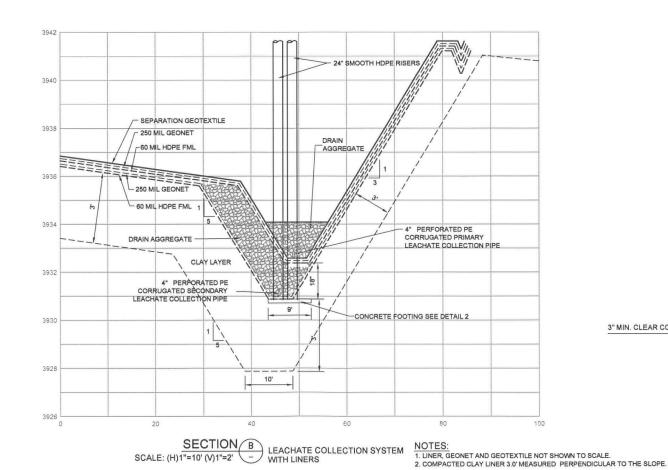 APPROVED BY
 MJO
 1/18/07

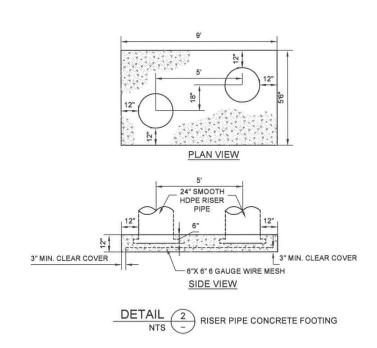 SCALE:
 AS NOTED

Hydrometrics, Inc.
Consulting Scientists and Engineers
Helena, Montana 59601


ASARCO LLC - EAST HELENA PLANT

CAMU PHASE 2 CELL PROJECT

LEACHATE DETECTION, COLLECTION, AND REMOVAL SYSTEM


SECTIONS AND DETAILS


DRAWING FILE NUMBER
605202H029.dwg
AUTOCAD 2004 DRAWING (DWG)
SHEET NUMBER REV
29

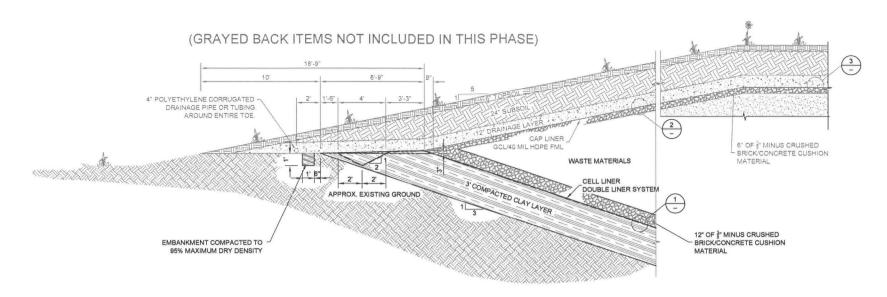


#### TYPICAL SECTION OF COMPLETED CAMU PHASE 2 CELL

SCALE: 1"=4'

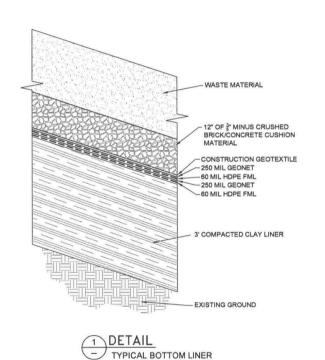

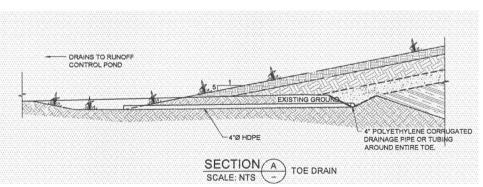

-24" SUBSOIL -12" DRAINAGE LAYER 40 MIL HDPE FML 6" OF 3" MINUS CRUSHED BRICK/CONCRETE CUSHION MATERIAL - WASTE 2 DETAIL
TYPICAL CAP CONSTRUCTION ON SLOPES SCALE: NTS (NOT INCLUDED IN THIS PHASE)

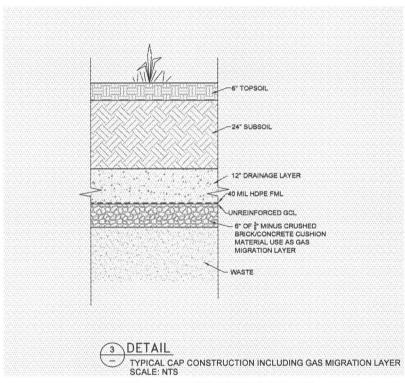


(NOT INCLUDED IN THIS PHASE)

-4"Ø HDPE	4" POLYETHYL DRAINAGE PIP AROUND ENTI
SECTION A TOE DRAIN	
(NOT INCLUDED IN THIS PHASE	SE)

NO BY DATE DESCRIPTION NO BY DATE	SCALE VERIFICATION BAR IS ONE INCH ON BAR IS ONE INCH ON	ASARCO LLC - EAST HELENA PLANT DRAWING FILE NUN	JIVIDEIX
	ORIGINAL DRAWNG DRAWN BY SDP 12/28/08 Consulting Scientists and Engineers	CAMU PHASE 2 CELL PROJECT 605202H030.dwg	NG (DWG)
APPLISION APPLIS	O CHECKED BY MWR 1/11/07 CONSTITUTE SCIENCES AND ENGINEERS	CAP AND BOTTOM LINER SHEET NUMBER	REV
2 2	IF NOT ONE INCH ON THIS SHEET, ADJUST  APPROVED BY MJO 1/12/07 Helena, Montana 59601 SO20 BOZEMBA AVERUE		$\wedge$
	SCALES ACCORDINGLY SCALE: AS NOTED (406) 443-4950	DETAILS 30	



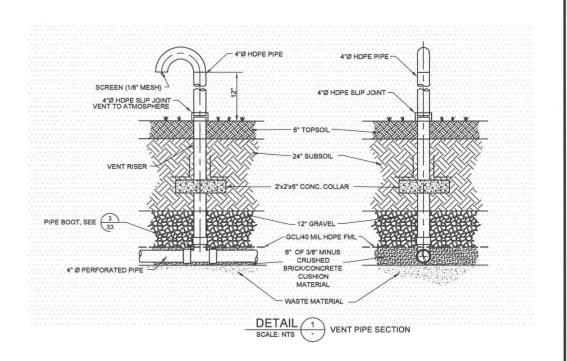

#### CONSTRUCTION PROJECT CONTROL POINTS

POINT	NORTHING	EASTING	ELEVATION	DESCRIPTION
1	8812.08	7197.71	3952.51	MW5
2	9296.77	7807.35	3934.54	MW6
3	8376.8943	7685.1041	3954.97	MW-8
4	8376.8165	7262.8426	3961.72	MW-9
5	8974.659	7811.757	3942.6	MW-10

#### CONSTRUCTION CAPPING CONTROL POINTS


POINT	NORTHING	EASTING	ELEVATION	DESCRIPTION
29	8710.8343	7325.8935	3958.84	TOP OF CAP
30	8999.5717	7579.6401	3949	TOP OF CAP
31	8763.2501	7880.946	3949	TOP OF CAP
32	8729.3733	7893.8993	3949	TOP OF CAP
33	8457,9415	7608.451	3958.84	TOP OF CAP
34	9035.0968	7558.2053	3941	TOE OF CAP
35	9039.4102	7588.9005	3941	TOE OF CAP
36	8768.4777	7911.9393	3944	TOE OF CAP
37	8726.8943	7908.9421	3946	TOE OF CAP
38	8418.739	7628.0372	3951	TOE OF CAP
39	8416.0879	7597.2121	3951	TOE OF CAP
40	8691.8392	7283.8127	3951	TOE OF CAP
41	8729.3577	7279.8377	3950	TOE OF CAP


FINISHED GRADE PLAN WITH GAS VENT AND PIPING LOCATIONS

SCALE: 1"=50"

## (THIS SHEET NOT INCLUDED IN THIS PHASE)

NO	BY C	DATE DESCRIPTION	NO BY	DATE	SCALE VERIFICATION BAR IS ONE INCH ON	Project No.:	6052		Hydrometrics, Inc.	ASARCO LLC - EAST HELENA PLANT	DRAWING FILE NUMBER
SNO —		OINS			ORIGINAL DRAWING	DRAWN BY	SDP	12/11/06	Consulting Scientists and Engineers	CAMU PHASE 2 CELL PROJECT	605202H031.dwg AUTOCAD 2004 DRAWING (DWG)
	-	ES CONTRACTOR OF THE CONTRACTO	+		IF NOT ONE INCH ON	CHECKED E		1/17/07	Helena, Montana 59601	FINISHED GRADE PLAN WITH GAS VENT LOCATIONS	SHEET NUMBER REV
		<u> </u>			THIS SHEET, ADJUST SCALES ACCORDINGLY	SCALE: A	S NOTED		Helena, Montana 59601 3026 Bozonan Avenue (403) 443-4180	AND DETAILS	31

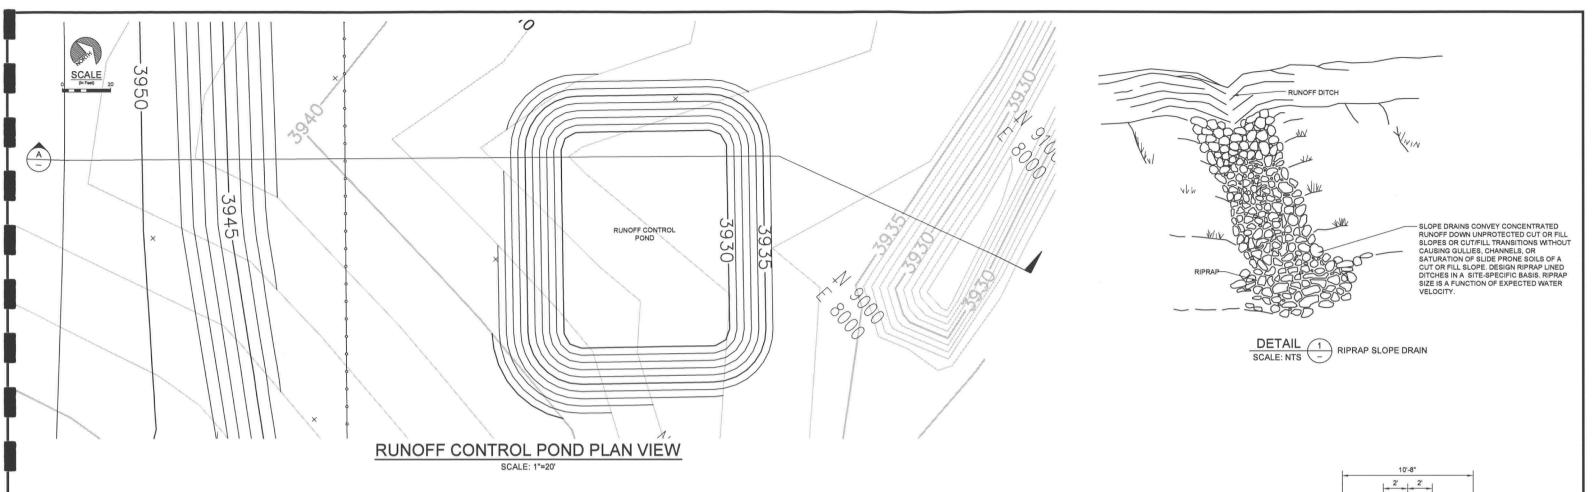


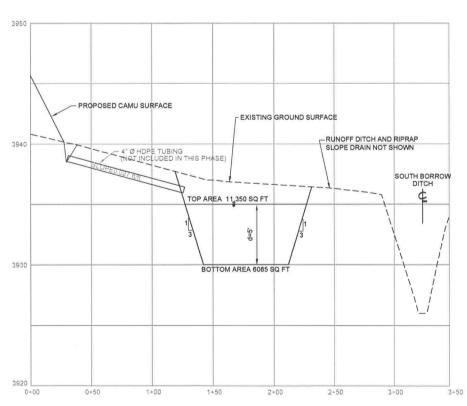

#### PROJECT QUANTITY TABLE

	(ROUGH QUANTITIES FOR BIDDING PURPOSES	ONLY)	
ITEM NO.	DESCRIPTION	QUANTITY	UNIT
1	Access Road-North( 1510 ft long x 30 ft wide)	5034	SY
2	Access Road-South (383 ft long x 30 ft wide)	1277	SY
3	Excavation & Stockpile - Topsoil (upper 6")	3,864	CY
4	Excavation & Stockpile - Subsoil (next 16")	10,304	CY
5	Excavation & Stockpile - Cell Excavation	53,832	CY
6	Subgrade Preparation, Grade & Compact	23,700	SY
7	Compacted Clay Liner	22,000	CY
8	HDPE, 60 mil	43,500	SY
9	Drainage Geonet, 250 mil	43,500	SY
10	Geotextile Construction Fabric	23,800	SY
11	Leachate Collection & Removal Systems- 4" Perf Pipe	757	LF
12	Leachate Collection & Removal Systems-Drain Gravel	500	CY
13	Leachate Collection & Removal Systems-24" Stand Pipes	38	LF
14	Runoff Control Pond	900	CY
15	Crush Brick/Concrete to 3/8" minus-Bottom of Cell	8,000	CY
16	Crush Brick/Concrete to 3/8" minus-Under Cap	3,550	CY
17	Load, Haul, Place & Compact Waste Materials	34,443	CY
18	Temporary Cover, RPE 25	24,500	SY
19	Load, Haul, Place & Compact Waste Materials-2008	21,275	CY
20	Load, Haul, Place & Compact Waste Materials-2009	2,100	CY
21	GCL	21,300	SY
22	HDPE, 40 mil	21,300	SY
21	Cap Drainage Collection, 4° HDPE	1,800	LF
22	Cap Drainage Culvert, 6" HDPE	71	LF
23	Cover Soil Layer	24.900	CY
24	Permanent Run-on Diversion Ditches	750	LF
25	Seed, Fertilize, & Mulch - Off Plant	13.1	ACRE
26	Woven Wire Farm Fence	2,200	LF
27	Chain Link Fence with Appurtenances	2.200	LF

(GRAYED BACK ITEMS NOT INCLUDED IN THIS PHASE)

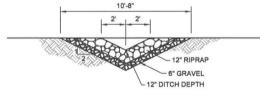

NOTE:
BANK PROTECTION TO BE TYPE 3.
USE CLASS I RIPRAP.

DETAIL 2 RIPRAP SLOPE DRAIN TYPICAL SECTION SCALE: NTS

SECTION A SCALE: (H) 1"=40 (V) 1"=4"	RUNOFF CONTROL POND
(GRAYED BACK ITEMS NOT INCLU	IDED IN THIS PHASE)

T	NO	BY	DATE	DESCRIPTION	1000	10	BY	DATE	SCALE VERIFICATION
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10N ON	Project No.: 6052	2	
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Hydrometrics, Inc.	~
Consulting Scientists and Engineers	
Helena, Montana 59601	

ASARCO LLC - EAST HELENA PLANT	DRAWING FILE NUMBER	₹
CAMU PHASE 2 CELL PROJECT	605202H032.dwg	21
RUNOFF CONTROL POND PLAN AND	SHEET NUMBER	RI
RIPRAP SLOPE DRAIN DETAILS	32	1

